

INSULATION NOTES:

1. PROVIDE 75MM FOIL BACKED BLANKET TO

ENCLOSED SUB-FLOORS.

UNDERSIDE OF ALL ROOF SHEETS.
2. PROVIDE MIN R3.5 INSULATION BATTS TO FLAT CEILINGS, & MIN R3.5 INSULATION BATTS TO RAKED CEILINGS.
3. PROVIDE MIN R2.5 INSULATION BATTS TO ALL FRAMED EXTERNAL WALLS.
4. PROVIDE MIN R2.5 INSULATION BATTS TO ALL BRICK VENEER EXTERNAL WALLS.
5. PROVIDE MIN R1.0 INSULATION TO ALL CAVITY BRICK EXTERNAL WALLS.
6. PROVIDE MIN R2.0 UNDER-FLOOR INSULATION BATTS TO ALL SUSPENDED FLOORS ABOVE

EXTERIOR COLOURS & FINISHES:

1. PROPOSED ROOF: COLORBOND CUSTOM ORB SHEET METAL ROOF IN COLORBOND PAPERBARK.

2. GUTTERS, DOWNPIPES & FLASHING TO BE COLORBOND PAPERBARK.

3. EXTERNAL WALL CLADDING: JAMES HARDIE SCYON LINEA EXTERNAL WALL CLADDING, FIX VERTICALLY.

4. NEW WINDOW & DOOR FRAMES TO BE POWDER COATED TO MATCH COLORBOND PAPERBARK.

5. BUSHFIRE SHUTTERS TO BE POWDER COATED TO MATCH COLORBOND PAPERBARK.

5. NEW FACE BRICKWORK TO BE AUSTRAL BRICK'S EVERY DAY LIFE RANGE IN COLOUR 'ENGAGE', OR

INTERNAL WALL NOTES:
ALL INTERNAL WALLS TO BE 92MM
METAL STUD WALLS LINED WITH 10MM
GYPROCK PLASTERBOARD SHEETS
DIRECT FIXED TO EITHER SIDE UNLESS

FLOOD CONSTRUCTION NOTES:
(REFER TO FLOOD IMPACT ASSESSMENT, NOVEMBER
2018, PREPARED BY HYDRO SPACIAL PTY LTD).
- The 1% AEP flood level is 859.08 m AHD for the upper ground

NOTED OTHERWISE

floor level.

- The required FFL for the upper ground floor level is **859.35 m AHD**.

- There is no flood extent to the ground floor level or the lower ground floor level, therefore there are no requirements for finished floor levels to the lower levels of the house.
- It is recommended that the building is constructed using flood compatible materials below the level of the 1% AEP plus freeboard and constructed in such a manner that it can withstand the flood forces.

It is recommended that the building is constructed as per BCA/ NCC Construction of Buildings in Flood Hazard Areas.

NOTES:

1. ALL CONSTRUCTION DETAILING TO BE TO
BAL FZ-FLAME ZONE REQUIREMENTS.
2. ALL NEW WORK TO COMPLY WITH AS 3959
SECTIONS 3 & 9 CONSTRUCTION OF BUILDINGS
IN BUSHFIRE PRONE AREAS.
3. NEW EXTERNAL CLADDING TO BE JAMES HAR

IN BUSHFIRE PRONE AREAS.

3. NEW EXTERNAL CLADDING TO BE JAMES HARDIE SCYON LINEA180MM HIGH X 16MM TK WEATHERBOARD WALL CLADDING, FIXED HORIZONTALLY TO MANUFACTURER'S SPECIFICATION, & TO ACHIEVE A MIN FRL 60/60/60 IN ACCORDANCE WITH AS 1530 (UNLESS NOTED OTHERWISE). LINE 2 X 16MM FIRECHEK GYPROCK SHEETS TO THE OUTSIDE OF THE WALL STUD. FIX SARKING OVER OUTER FACE OF SHEETS PRIOR TO FIXING EXTERNAL CLADDING.

4. ALL FLOOR FRAMING BEAMS, ROOF/CEILING BEAMS, CONCRETE SLAB & FOOTINGS TO ENG. DETAILS.

5. ALL FOOTINGS & PIERS TO BE TO ENG. DETAILS.

6. CONFIRM ALL EXCAVATION REQUIREMENTS PRIOR TO CONSTRUCTION.

6. PROVIDE ALL FLASHING AS PER BCA/NCC REQUIREMENTS.

**AMENDMENTS** 21-09-22 PROJECT: PROPOSED RESIDENCE NO 40 WILSON STREET, WENTWORTH FALLS, NSW 2782 Mr Chang Kyun Son. PROPOSED SECTIONS AA & BB **BIO-BUILDING DESIGN** PTY LIMITED ARCHITECTS 3 HOME STREET, FAULCONBRIDGE NSW, 2776 Tel: (02) 4751 1846 Fax: (02) 4751 7098 Email: biobuild@pnc.com.au Registered Architect: John Van der Have ARB 3690

DRAWN:

1:100 @ A2

DATE:

21/09/2022

DATE:

21/09/2022

DATE:

1:00 @ A2

DRAWN:

DRAWN:

JVH/VK

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DRAWN:

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DRAWN:


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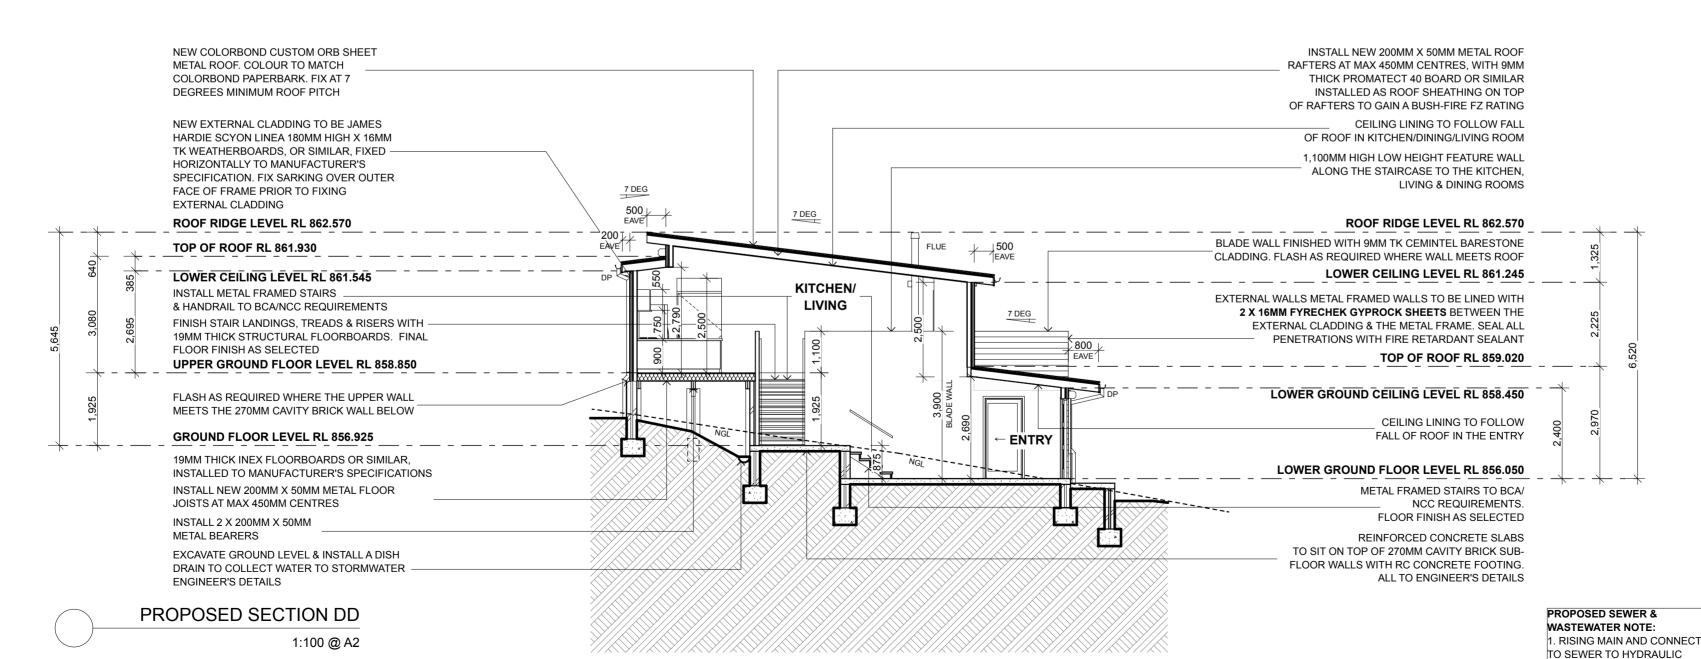
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#### PROPOSED SECTION CC

1:100 @ A2



# BAL RATING: FZ-FLAME ZONE

INSULATION NOTES:

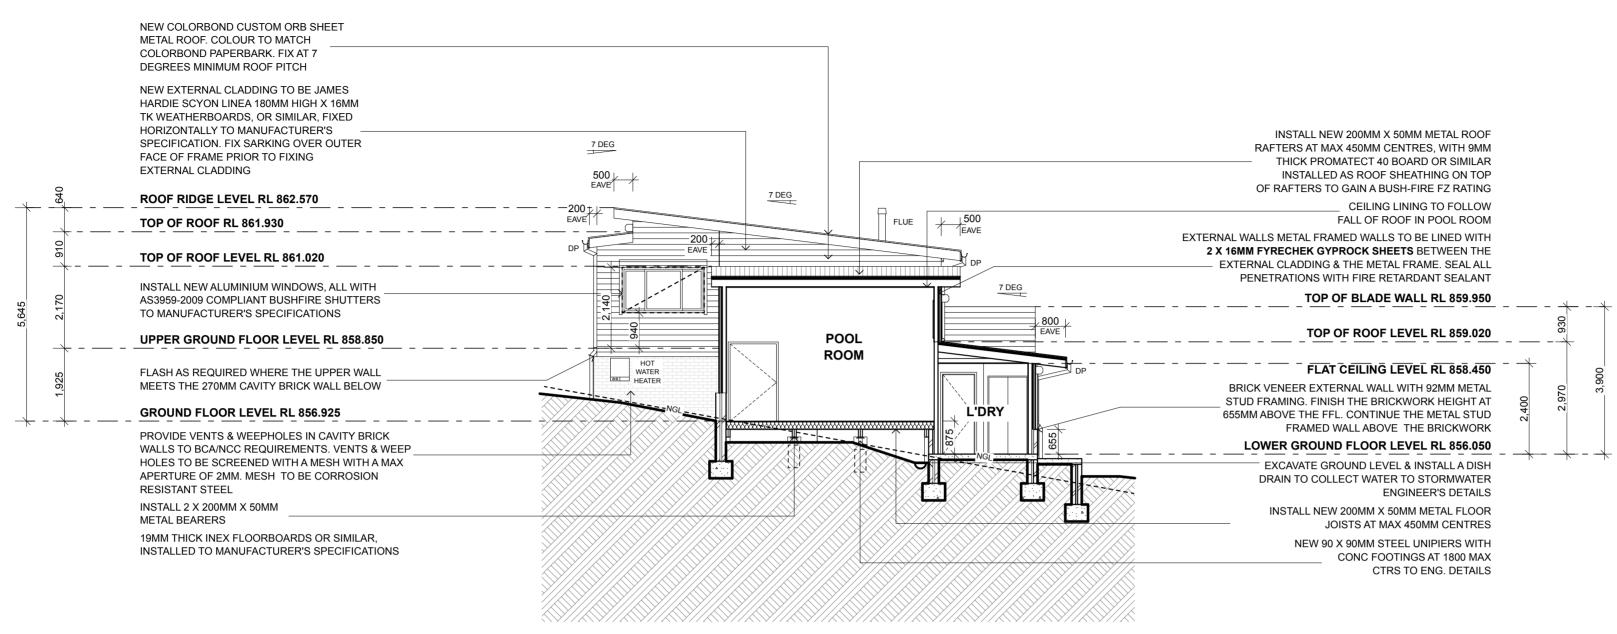1. PROVIDE 75MM FOIL BACKED BLANKET TO UNDERSIDE OF ALL ROOF SHEETS.
2. PROVIDE MIN R3.5 INSULATION BATTS TO FLAT CEILINGS, & MIN R3.5 INSULATION BATTS TO RAKED CEILINGS.
3. PROVIDE MIN R2.5 INSULATION

BATTS TO ALL FRAMED EXTERNAL WALLS.

4. PROVIDE MIN R2.5 INSULATION
BATTS TO ALL BRICK VENEER EXTERNAL WALLS.

5. PROVIDE MIN R1.0 INSULATION
TO ALL CAVITY BRICK EXTERNAL WALLS.

6. PROVIDE MIN R2.0 UNDER-FLOOR INSULATION
BATTS TO ALL SUSPENDED FLOORS ABOVE
ENCLOSED SUB-FLOORS.

EXTERIOR COLOURS & FINISHES:

1. PROPOSED ROOF: COLORBOND CUSTOM ORB SHEET METAL ROOF IN COLORBOND PAPERBARK.

2. GUTTERS, DOWNPIPES & FLASHING TO BE COLORBOND PAPERBARK.

3. EXTERNAL WALL CLADDING: JAMES HARDIE SCYON LINEA EXTERNAL WALL CLADDING, FIX VERTICALLY.

4. NEW WINDOW & DOOR FRAMES TO BE POWDER COATED TO MATCH COLORBOND PAPERBARK.

5. BUSHFIRE SHUTTERS TO BE POWDER COATED TO MATCH COLORBOND PAPERBARK.

5. NEW FACE BRICKWORK TO BE AUSTRAL BRICK'S EVERY DAY LIFE RANGE IN COLOUR 'ENGAGE', OR

INTERNAL WALL NOTES:
ALL INTERNAL WALLS TO BE 92MM
METAL STUD WALLS LINED WITH 10MM
GYPROCK PLASTERBOARD SHEETS
DIRECT FIXED TO EITHER SIDE UNLESS
NOTED OTHERWISE

FLOOD CONSTRUCTION NOTES:
(REFER TO FLOOD IMPACT ASSESSMENT, NOVEMBER
2018, PREPARED BY HYDRO SPACIAL PTY LTD).
- The 1% AEP flood level is 859.08 m AHD for the upper ground

floor level.

- The required FFL for the upper ground floor level is **859.35 m AHD**.

- There is no flood extent to the ground floor level or the lower ground floor level, therefore there are no requirements for finished floor levels to the lower levels of the house.
- It is recommended that the building is constructed using flood compatible materials below the level of the 1% AEP plus freeboard and constructed in such a manner that it can withstand the flood forces.

- It is recommended that the building is constructed as per BCA/ NCC Construction of Buildings in Flood Hazard Areas.

NOTES:

ENGINEER'S DETAIL.

ENGINEER'S DETAIL.

SEWER TO HYDRAULIC

2. CONNECT WASTEWATER TO

1. ALL CONSTRUCTION DETAILING TO BE TO
BAL FZ-FLAME ZONE REQUIREMENTS.
2. ALL NEW WORK TO COMPLY WITH AS 3959
SECTIONS 3 & 9 CONSTRUCTION OF BUILDINGS
IN BUSHFIRE PRONE AREAS

IN BUSHFIRE PRONE AREAS. 3. NEW EXTERNAL CLADDING TO BE JAMES HARDIE SCYON LINEA180MM HIGH X 16MM TK WEATHERBOARD WALL CLADDING, FIXED HORIZONTALLY TO MANUFACTURER'S SPECIFICATION, & TO ACHIEVE A MIN FRL 60/60/60 IN ACCORDANCE WITH AS 1530 (UNLESS NOTED OTHERWISE). LINE 2 X 16MM FIRECHEK GYPROCK SHEETS TO THE OUTSIDE OF THE WALL STUD. FIX SARKING OVER OUTER FACE OF SHEETS PRIOR TO FIXING EXTERNAL CLADDING. 4. ALL FLOOR FRAMING BEAMS, ROOF/CEILING BEAMS, CONCRETE SLAB & FOOTINGS TO ENG. DETAILS. 5. ALL FOOTINGS & PIERS TO BE TO ENG. DETAILS. 6. CONFIRM ALL EXCAVATION REQUIREMENTS PRIOR TO CONSTRUCTION. 6. PROVIDE ALL FLASHING AS PER BCA/NCC REQUIREMENTS.

	AMENDMENTS: B F	or Development Approval	21-09-22
	PROJECT:		
	PROPOSED NO 40 WILSON ST WENTWORTH FAL (PART LOT 5 IN SE	LS, NSW 2782	
	For Mr Chang Kyun Sor	1.	
	DRAWING.		
	PROPOSE	D	
	SECTIONS	CC & DD	
		JILDING DES	
	PTY LIMIT	ED ARCHI	
	3 HOME S	TREET, FAULCONBE	_
	Fax: (02) 475	Tel: (02) <b>475</b> ′ 1 7098 Email: biobuild@pnc rchitect: John Van der Have AR	.com.au
ION	SCALE:	DRAWN:	DRAWING NO:
		JVH/VK	ı


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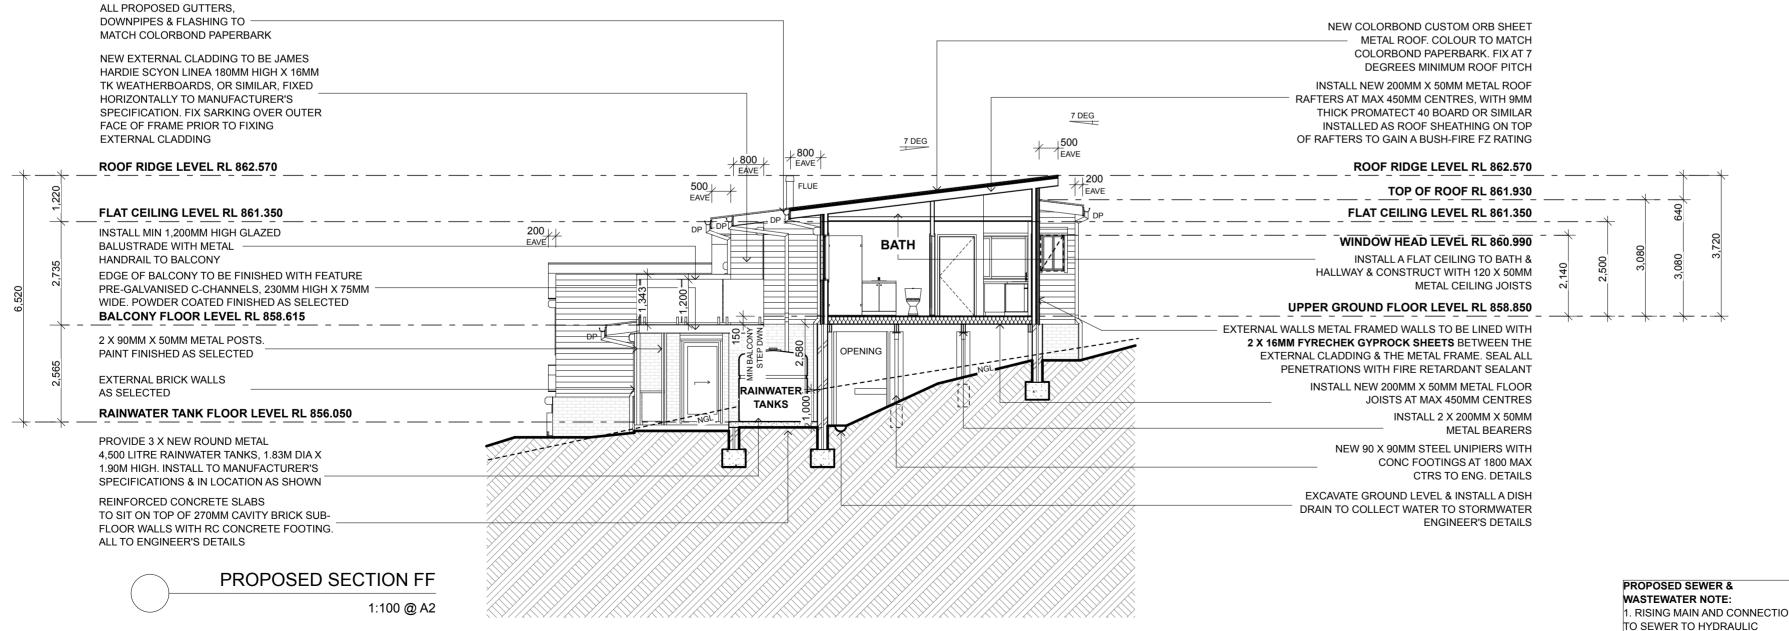
JVH

06

1:100 @ A2

21/09/2022



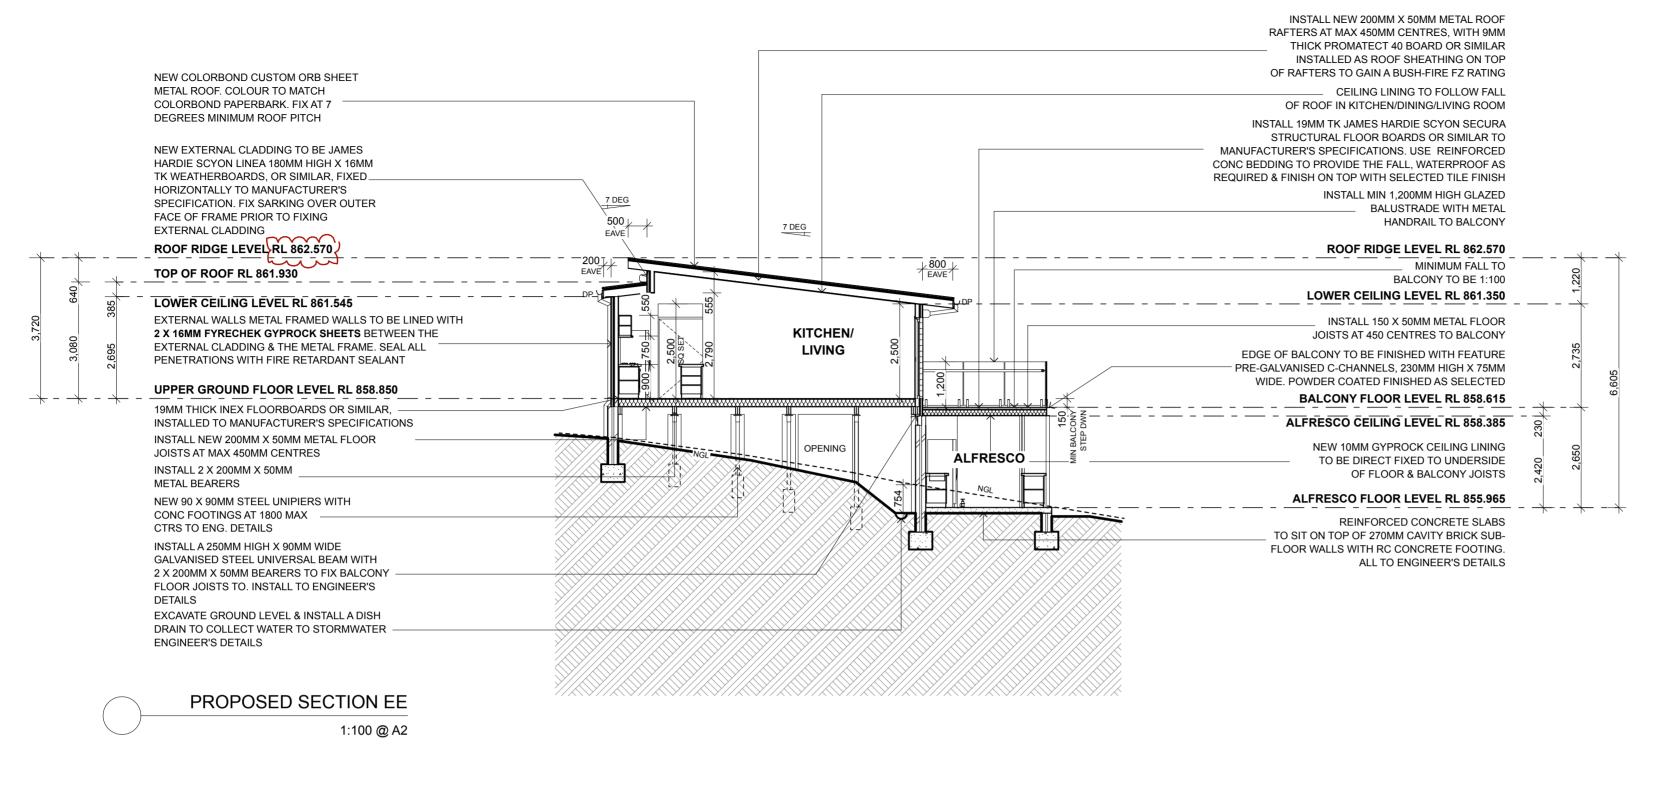

## BAL RATING: FZ-FLAME ZONE

INSULATION NOTES:

1. PROVIDE 75MM FOIL BACKED BLANKET TO

UNDERSIDE OF ALL ROOF SHEETS.
2. PROVIDE MIN R3.5 INSULATION BATTS TO FLAT CEILINGS, & MIN R3.5 INSULATION BATTS TO RAKED CEILINGS.
3. PROVIDE MIN R2.5 INSULATION BATTS TO ALL FRAMED EXTERNAL WALLS.
4. PROVIDE MIN R2.5 INSULATION BATTS TO ALL BRICK VENEER EXTERNAL WALLS.
5. PROVIDE MIN R1.0 INSULATION TO ALL CAVITY BRICK EXTERNAL WALLS.

6. PROVIDE MIN R2.0 UNDER-FLOOR INSULATION

BATTS TO ALL SUSPENDED FLOORS ABOVE

ENCLOSED SUB-FLOORS.

EXTERIOR COLOURS & FINISHES:

1. PROPOSED ROOF: COLORBOND CUSTOM ORB SHEET METAL ROOF IN COLORBOND PAPERBARK.

2. GUTTERS, DOWNPIPES & FLASHING TO BE COLORBOND PAPERBARK.

3. EXTERNAL WALL CLADDING: JAMES HARDIE SCYON LINEA EXTERNAL WALL CLADDING, FIX VERTICALLY.

4. NEW WINDOW & DOOR FRAMES TO BE POWDER COATED TO MATCH COLORBOND PAPERBARK.

5. BUSHFIRE SHUTTERS TO BE POWDER COATED TO MATCH COLORBOND PAPERBARK.

5. NEW FACE BRICKWORK TO BE AUSTRAL BRICK'S EVERY DAY LIFE RANGE IN COLOUR 'ENGAGE', OR

INTERNAL WALL NOTES:
ALL INTERNAL WALLS TO BE 92MM
METAL STUD WALLS LINED WITH 10MM
GYPROCK PLASTERBOARD SHEETS
DIRECT FIXED TO EITHER SIDE UNLESS
NOTED OTHERWISE

FLOOD CONSTRUCTION NOTES:
(REFER TO FLOOD IMPACT ASSESSMENT, NOVEMBER
2018, PREPARED BY HYDRO SPACIAL PTY LTD).
- The 1% AEP flood level is 859.08 m AHD for the upper ground

floor level.

- The required FFL for the upper ground floor level is **859.35 m AHD**.

- There is no flood extent to the ground floor level or the lower ground floor level, therefore there are no requirements for finished floor levels to the lower levels of the house.
- It is recommended that the building is constructed using flood compatible materials below the level of the 1% AEP plus freeboard and constructed in such a manner that it can withstand the flood forces.

- It is recommended that the building is constructed as per BCA/ NCC Construction of Buildings in Flood Hazard Areas.

NOTES:

ENGINEER'S DETAIL

ENGINEER'S DETAIL.

SEWER TO HYDRAULIC

2. CONNECT WASTEWATER TO

1. ALL CONSTRUCTION DETAILING TO BE TO BAL FZ-FLAME ZONE REQUIREMENTS.
2. ALL NEW WORK TO COMPLY WITH AS 3959 SECTIONS 3 & 9 CONSTRUCTION OF BUILDINGS IN BUSHFIRE PRONE AREAS.
3. NEW EXTERNAL CLADDING TO BE JAMES HAR LINEA 180MM HIGH X 16MM TK WEATHERBOARD

IN BUSHFIRE PRONE AREAS.

3. NEW EXTERNAL CLADDING TO BE JAMES HARDIE SCYON LINEA180MM HIGH X 16MM TK WEATHERBOARD WALL CLADDING, FIXED HORIZONTALLY TO MANUFACTURER'S SPECIFICATION, & TO ACHIEVE A MIN FRL 60/60/60 IN ACCORDANCE WITH AS 1530 (UNLESS NOTED OTHERWISE). LINE 2 X 16MM FIRECHEK GYPROCK SHEETS TO THE OUTSIDE OF THE WALL STUD. FIX SARKING OVER OUTER FACE OF SHEETS PRIOR TO FIXING EXTERNAL CLADDING.

4. ALL FLOOR FRAMING BEAMS, ROOF/CEILING BEAMS, CONCRETE SLAB & FOOTINGS TO ENG. DETAILS.

5. ALL FOOTINGS & PIERS TO BE TO ENG. DETAILS.

6. CONFIRM ALL EXCAVATION REQUIREMENTS PRIOR TO CONSTRUCTION.

6. PROVIDE ALL FLASHING AS PER BCA/NCC REQUIREMENTS.

21-09-22


	AMENDMENTS: B Fo	or Development Approval	
	PROJECT:		
		RESIDENCE	
	NO 40 WILSON STF WENTWORTH FALL (PART LOT 5 IN SEC	S, NSW 2782	
	For Mr Chang Kyun Son		
	DRAWING:		
	DDODOOF	_	
	PROPOSEI SECTIONS		
		ILDING DES	
	PTY LIMITE	ED ARCHI	TECT
		TREET, FAULCONBE	
		Tel: (02) <b>475</b> 7098 Email: biobuild@pnochitect: John Van der Have AR	.com.au
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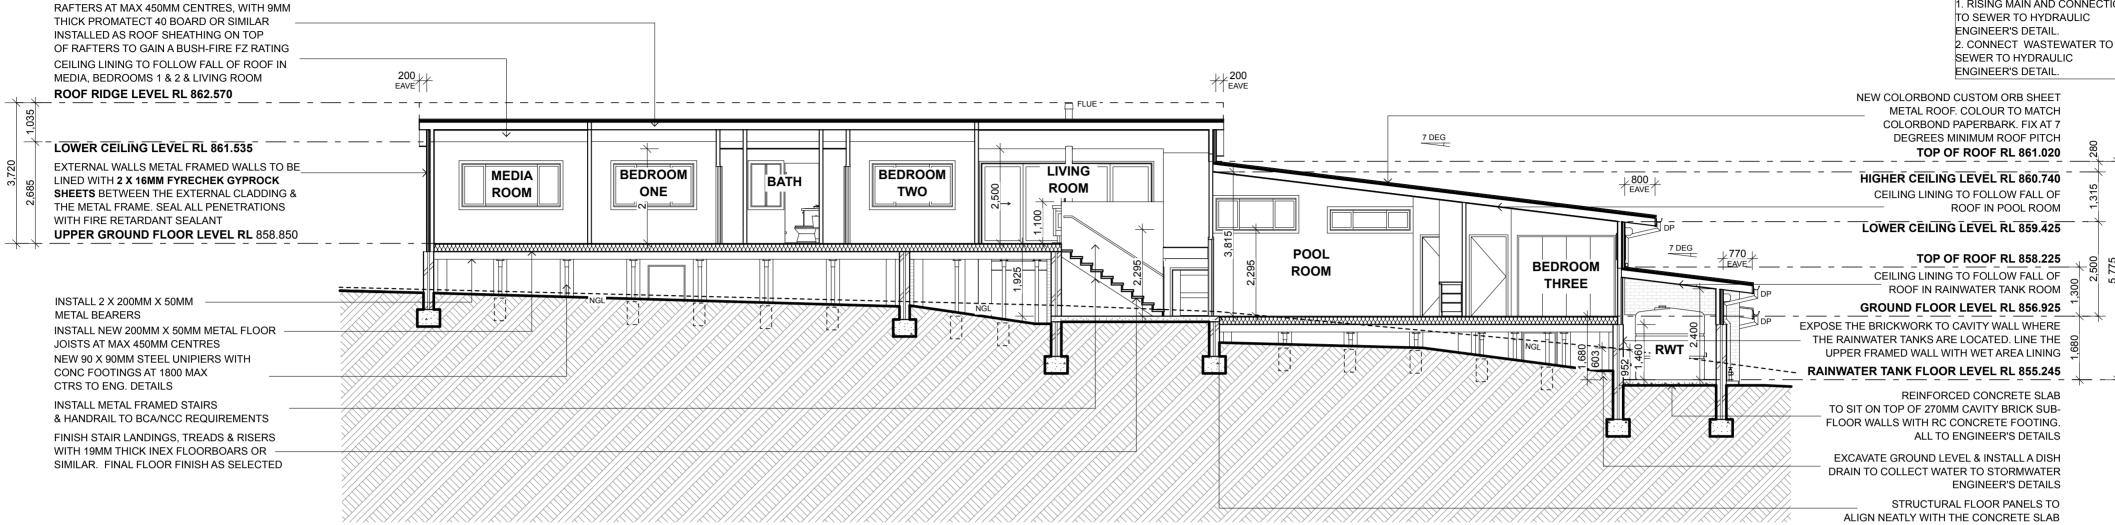
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ATE: 21/09/2022 JVH

DRAWNOS NO: DRAWING NO:



PROPOSED SEWER & WASTEWATER NOTE: 1. RISING MAIN AND CONNECTION 2. CONNECT WASTEWATER TO

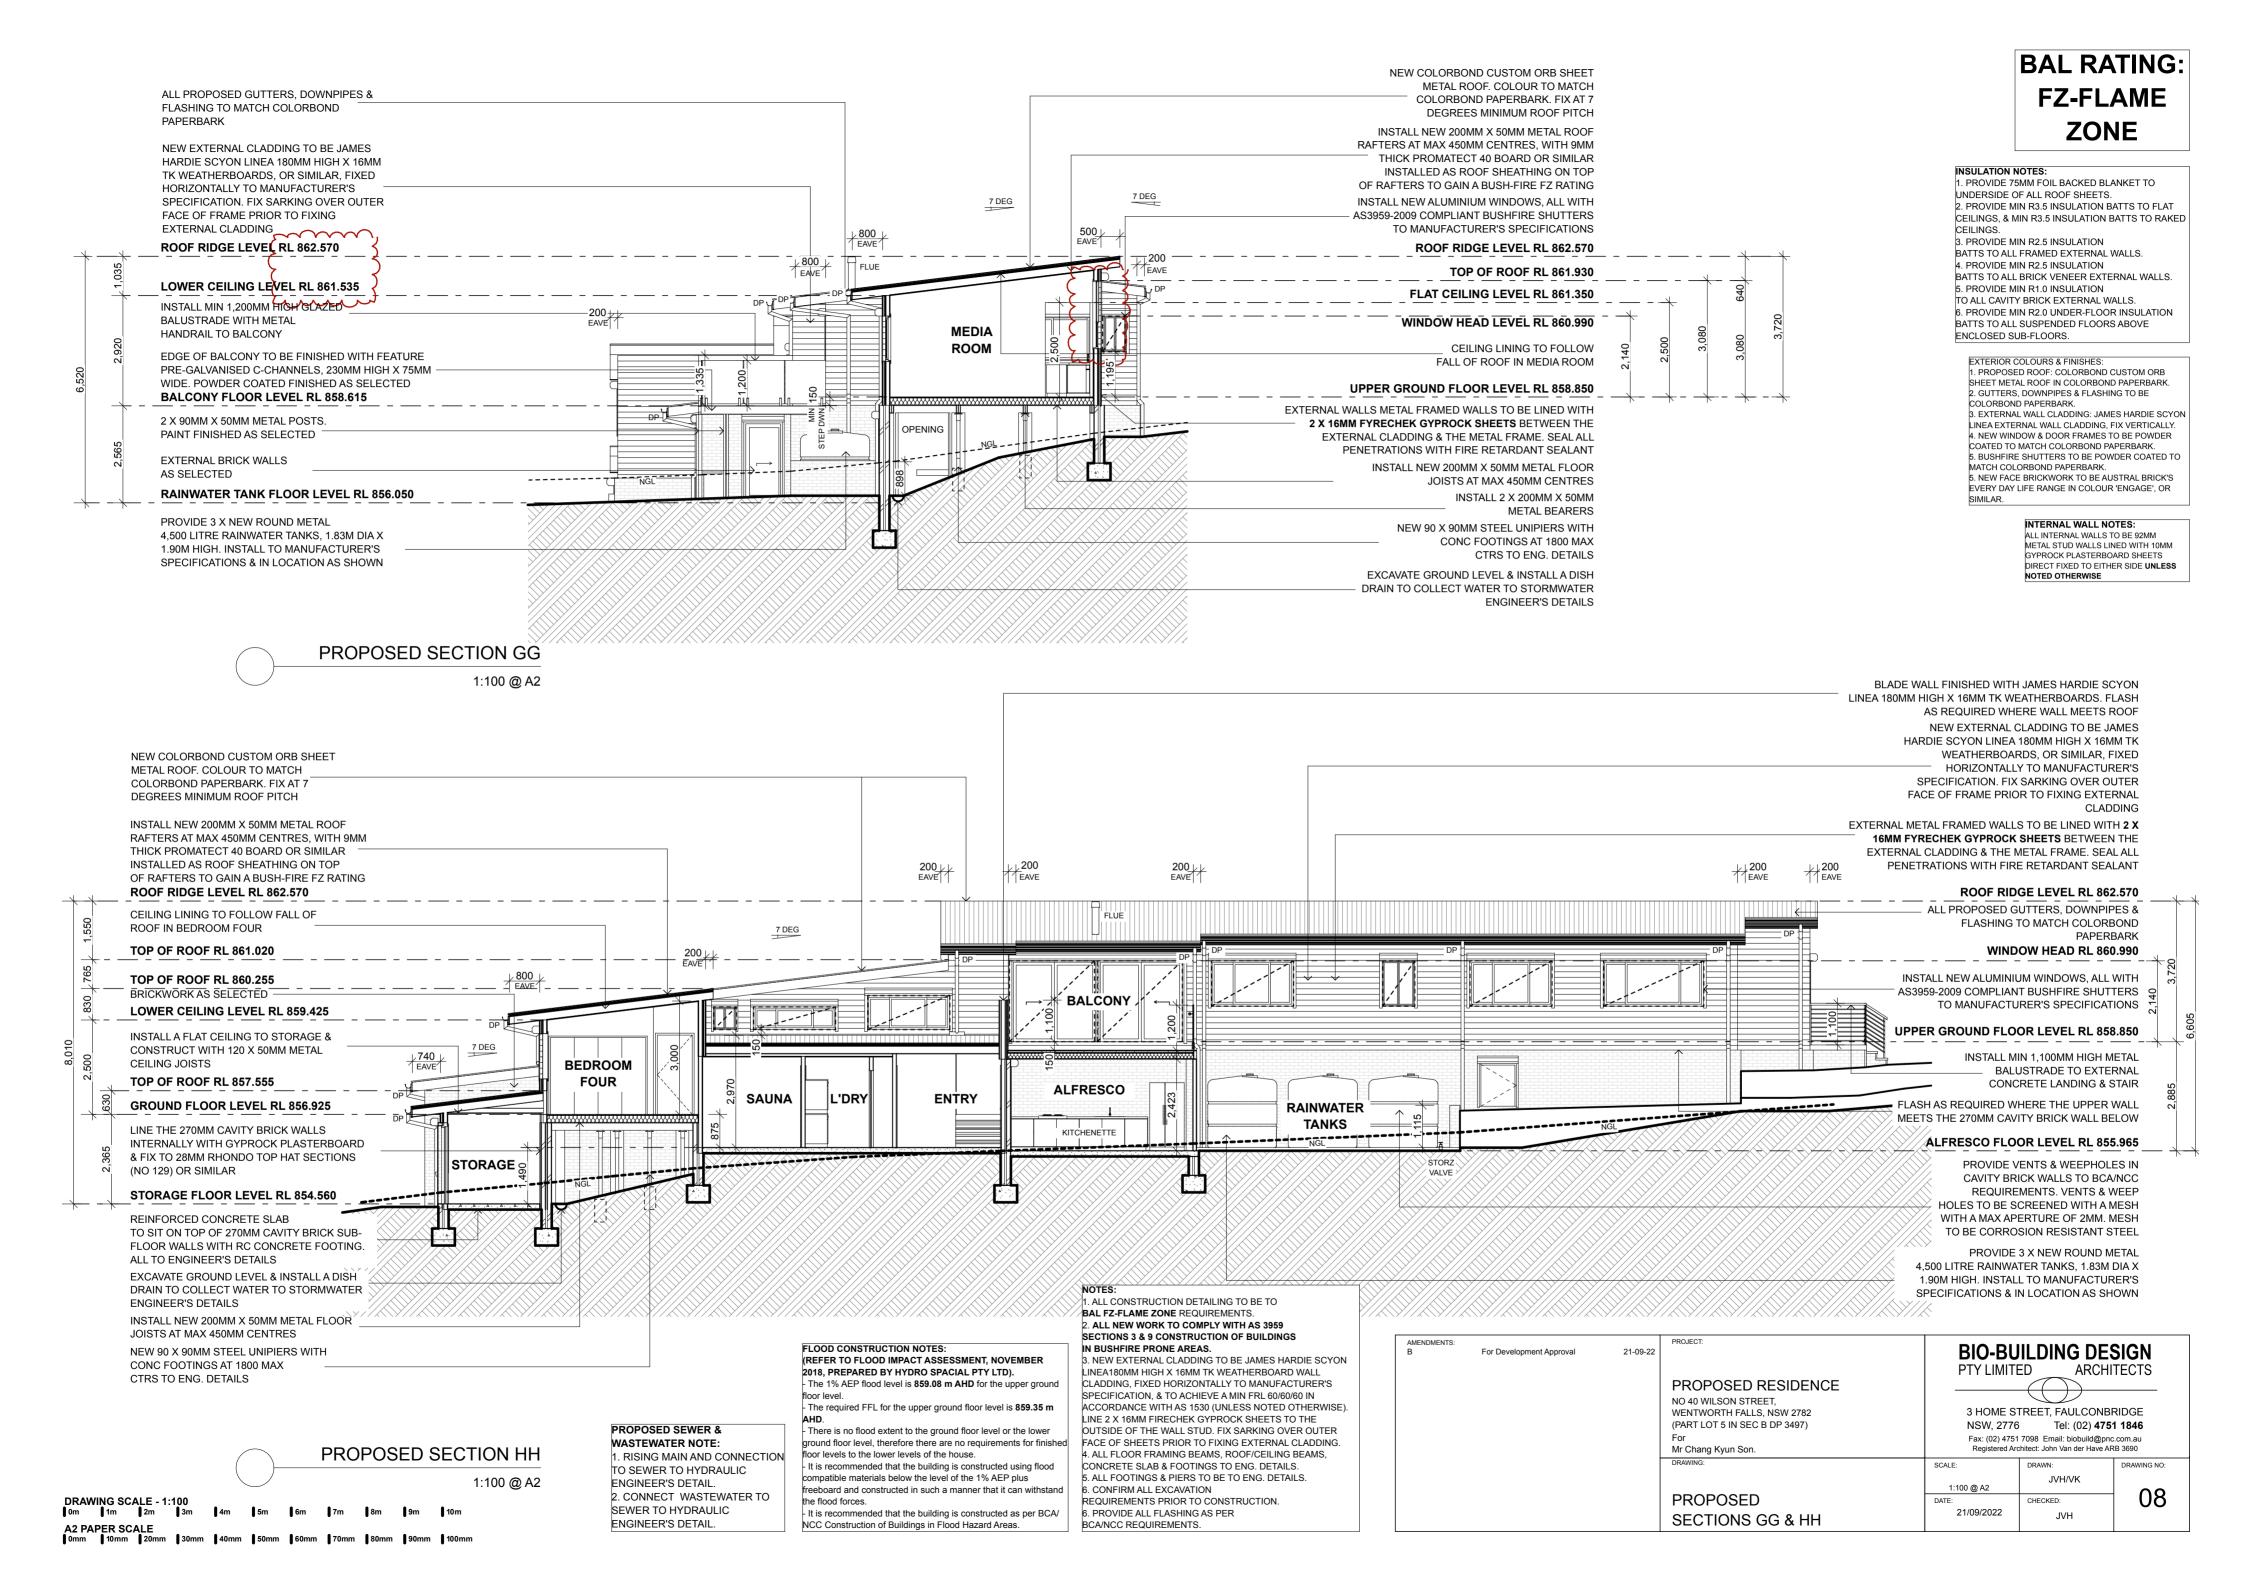

PROPOSED SECTION II

INSTALL NEW 200MM X 50MM METAL ROOF

1:100 @ A2

BAL FZ-FLAME ZONE REQUIREMENTS. 2. ALL NEW WORK TO COMPLY WITH AS 3959 SECTIONS 3 & 9 CONSTRUCTION OF BUILDINGS FLOOD CONSTRUCTION NOTES: IN BUSHFIRE PRONE AREAS. (REFER TO FLOOD IMPACT ASSESSMENT, NOVEMBER 3. NEW EXTERNAL CLADDING TO BE JAMES HARDIE SCYON 2018, PREPARED BY HYDRO SPACIAL PTY LTD). LINEA180MM HIGH X 16MM TK WEATHERBOARD WALL - The 1% AEP flood level is 859.08 m AHD for the upper ground CLADDING, FIXED HORIZONTALLY TO MANUFACTURER'S EXTERIOR COLOURS & FINISHES: SPECIFICATION, & TO ACHIEVE A MIN FRL 60/60/60 IN 1. PROPOSED ROOF: COLORBOND CUSTOM ORB The required FFL for the upper ground floor level is 859.35 m SHEET METAL ROOF IN COLORBOND PAPERBARK. ACCORDANCE WITH AS 1530 (UNLESS NOTED OTHERWISE). 2. GUTTERS, DOWNPIPES & FLASHING TO BE LINE 2 X 16MM FIRECHEK GYPROCK SHEETS TO THE

There is no flood extent to the ground floor level or the lower ground floor level, therefore there are no requirements for finished floor levels to the lower levels of the house.

NOTES:

1. ALL CONSTRUCTION DETAILING TO BE TO

4 ALL FLOOR FRAMING BEAMS ROOF/CELLING BEAMS

CONCRETE SLAB & FOOTINGS TO ENG. DETAILS.

REQUIREMENTS PRIOR TO CONSTRUCTION.

6. CONFIRM ALL EXCAVATION

BCA/NCC REQUIREMENTS.

6. PROVIDE ALL FLASHING AS PER

5. ALL FOOTINGS & PIERS TO BE TO ENG. DETAILS.

It is recommended that the building is constructed using flood compatible materials below the level of the 1% AEP plus freeboard and constructed in such a manner that it can withstand the flood forces.

- It is recommended that the building is constructed as per BCA/ NCC Construction of Buildings in Flood Hazard Areas.

PROJECT: Mr Chang Kyun Son. OUTSIDE OF THE WALL STUD. FIX SARKING OVER OUTER FACE OF SHEETS PRIOR TO FIXING EXTERNAL CLADDING.

PROPOSED RESIDENCE NO 40 WILSON STREET, WENTWORTH FALLS, NSW 2782 PROPOSED SECTION II **BIO-BUILDING DESIGN** PTY LIMITED ARCHITECTS 3 HOME STREET, FAULCONBRIDGE NSW, 2776 Tel: (02) **4751 1846** Fax: (02) 4751 7098 Email: biobuild@pnc.com.au Registered Architect: John Van der Have ARB 3690

JVH/VK 1:100 @ A2 09 21/09/2022 JVH

For Development Approval

21-09-22

COLORBOND PAPERBARK. 3. EXTERNAL WALL CLADDING: JAMES HARDIE SCYON LINEA EXTERNAL WALL CLADDING, FIX VERTICALLY.
4. NEW WINDOW & DOOR FRAMES TO BE POWDER COATED TO MATCH COLORBOND PAPERBARK. 5 BUSHFIRE SHUTTERS TO BE POWDER COATED TO

MATCH COLORBOND PAPERBARK.

5. NEW FACE BRICKWORK TO BE AUSTRAL BRICK'S

EVERY DAY LIFE RANGE IN COLOUR 'ENGAGE', OR

INTERNAL WALL NOTES: ALL INTERNAL WALLS TO BE 92MM METAL STUD WALLS LINED WITH 10MM GYPROCK PLASTERBOARD SHEETS DIRECT FIXED TO EITHER SIDE UNLESS NOTED OTHERWISE



INTERNAL WALL NOTES: ALL INTERNAL WALLS TO BE 92MM METAL STUD WALLS LINED WITH 10MM GYPROCK PLASTERBOARD SHEETS NOTED OTHERWISE

BCA/NCC REQUIREMENTS.

NOTES:

1. ALL CONSTRUCTION DETAILING TO BE TO BAL FZ-FLAME ZONE REQUIREMENTS. 2. ALL NEW WORK TO COMPLY WITH AS 3959 SECTIONS 3 & 9 CONSTRUCTION OF BUILDINGS IN BUSHFIRE PRONE AREAS. 3. NEW EXTERNAL CLADDING TO BE JAMES HARDIE SCYON LINEA180MM HIGH X 16MM TK WEATHERBOARD WALL CLADDING, FIXED HORIZONTALLY TO MANUFACTURER'S SPECIFICATION, & TO ACHIEVE A MIN FRL 60/60/60 IN ACCORDANCE WITH AS 1530 (UNLESS NOTED OTHERWISE). LINE 2 X 16MM FIRECHEK GYPROCK SHEETS TO THE OUTSIDE OF THE WALL STUD. FIX SARKING OVER OUTER FACE OF SHEETS PRIOR TO FIXING EXTERNAL CLADDING. 4. ALL FLOOR FRAMING BEAMS, ROOF/CEILING BEAMS, CONCRETE SLAB & FOOTINGS TO ENG. DETAILS. 5. ALL FOOTINGS & PIERS TO BE TO ENG. DETAILS. 6. CONFIRM ALL EXCAVATION REQUIREMENTS PRIOR TO CONSTRUCTION. 6. PROVIDE ALL FLASHING AS PER

PROPOSED SEWER & WASTEWATER NOTE: TO SEWER TO HYDRAULIC

1. RISING MAIN AND CONNECTION ENGINEER'S DETAIL. 2. CONNECT WASTEWATER TO SEWER TO HYDRAULIC ENGINEER'S DETAIL.

EXTERIOR COLOURS & FINISHES: . PROPOSED ROOF: COLORBOND CUSTOM ORB SHEET METAL ROOF IN COLORBOND PAPERBARK. 2. GUTTERS, DOWNPIPES & FLASHING TO BE COLORBOND PAPERBARK.

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CEILINGS.

BATTS TO ALL FRAMED EXTERNAL WALLS.

TO ALL CAVITY BRICK EXTERNAL WALLS.

BATTS TO ALL SUSPENDED FLOORS ABOVE

BATTS TO ALL BRICK VENEER EXTERNAL WALLS.

6. PROVIDE MIN R2.0 UNDER-FLOOR INSULATION

4. PROVIDE MIN R2.5 INSULATION

5. PROVIDE MIN R1.0 INSULATION

ENCLOSED SUB-FLOORS.

FLOOD CONSTRUCTION NOTES: INSULATION NOTES: (REFER TO FLOOD IMPACT ASSESSMENT, NOVEMBER 2018, PREPARED BY HYDRO SPACIAL PTY LTD). 1. PROVIDE 75MM FOIL BACKED BLANKET TO UNDERSIDE OF ALL ROOF SHEETS. - The 1% AEP flood level is 859.08 m AHD for the upper ground

2. PROVIDE MIN R3.5 INSULATION BATTS TO FLAT - The required FFL for the upper ground floor level is 859.35 m CEILINGS, & MIN R3.5 INSULATION BATTS TO RAKED 3. PROVIDE MIN R2.5 INSULATION

the flood forces.

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- It is recommended that the building is constructed as per BCA/ NCC Construction of Buildings in Flood Hazard Areas.


AMENDMENTS: B	For Development Approval	21-09-22	PROJECT:	BIO-BU	IILDING DE	SIGN
			PROPOSED RESIDENCE NO 40 WILSON STREET, WENTWORTH FALLS, NSW 2782 (PART LOT 5 IN SEC B DP 3497) For Mr Chang Kyun Son.	NSW, 2776 Fax: (02) 475	TREET, FAULCONB	11 1846 c.com.au
			DRAWING:	SCALE: 1:100 @ A2	DRAWN: JVH/VK	DRAWING NO:
			PROPOSED NORTHERN (FRONT) ELEVATION	DATE: 21/09/2022	CHECKED: JVH	10

DRAWING SCALE - 1:100 0m 1m 2m 3m 4m 5m 6m 7m 8m 9m 10m

PROPOSED SEWER &
WASTEWATER NOTE:

1. RISING MAIN AND CONNECTION
TO SEWER TO HYDRAULIC
ENGINEER'S DETAIL.

2. CONNECT WASTEWATER TO
SEWER TO HYDRAULIC
ENGINEER'S DETAIL.

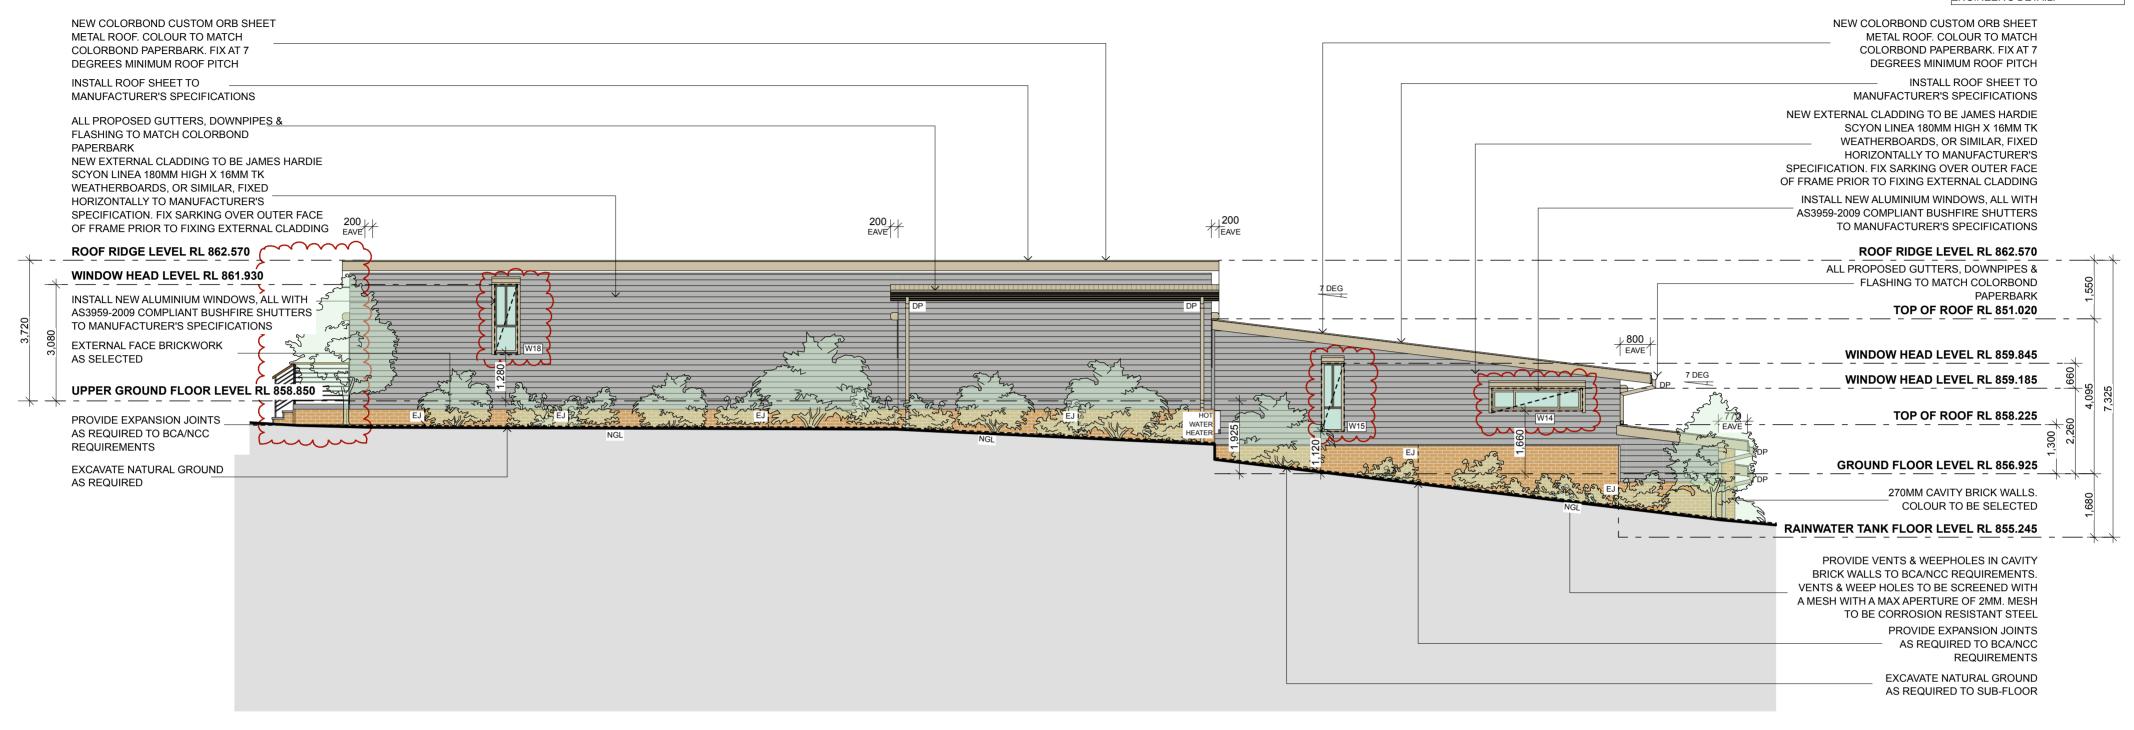

PROPOSED SOUTHERN
(REAR) ELEVATION

1:100 @ A2

INTERNAL WALL NOTES:
ALL INTERNAL WALLS TO BE 92MM
METAL STUD WALLS LINED WITH 10MM
GYPROCK PLASTERBOARD SHEETS
DIRECT FIXED TO EITHER SIDE UNLESS
NOTED OTHERWISE

NOTES: 1. ALL CONSTRUCTION DETAILING TO BE TO BAL FZ-FLAME ZONE REQUIREMENTS. 2. ALL NEW WORK TO COMPLY WITH AS 3959 SECTIONS 3 & 9 CONSTRUCTION OF BUILDINGS IN BUSHFIRE PRONE AREAS. 3. NEW EXTERNAL CLADDING TO BE JAMES HARDIE SCYON LINEA180MM HIGH X 16MM TK WEATHERBOARD WALL CLADDING, FIXED HORIZONTALLY TO MANUFACTURER'S SPECIFICATION, & TO ACHIEVE A MIN FRL 60/60/60 IN ACCORDANCE WITH AS 1530 (UNLESS NOTED OTHERWISE). LINE 2 X 16MM FIRECHEK GYPROCK SHEETS TO THE OUTSIDE OF THE WALL STUD. FIX SARKING OVER OUTER FACE OF SHEETS PRIOR TO FIXING EXTERNAL CLADDING. 4. ALL FLOOR FRAMING BEAMS, ROOF/CEILING BEAMS, CONCRETE SLAB & FOOTINGS TO ENG. DETAILS. 5. ALL FOOTINGS & PIERS TO BE TO ENG. DETAILS. 6. CONFIRM ALL EXCAVATION REQUIREMENTS PRIOR TO CONSTRUCTION. 6. PROVIDE ALL FLASHING AS PER BCA/NCC REQUIREMENTS.

 EXTERIOR COLOURS & FINISHES:

1. PROPOSED ROOF: COLORBOND CUSTOM ORB
SHEET METAL ROOF IN COLORBOND PAPERBARK.

2. GUTTERS, DOWNPIPES & FLASHING TO BE
COLORBOND PAPERBARK.

COLORBOND PAPERBARK.

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MATCH COLORBOND PAPERBARK.

5. NEW FACE BRICKWORK TO BE AUSTRAL BRICK'S
EVERY DAY LIFE RANGE IN COLOUR 'ENGAGE', OR
SIMILAR.

### INSULATION NOTES:

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BATTS TO ALL BRICK VENEER EXTERNAL WALLS.
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TO ALL CAVITY BRICK EXTERNAL WALLS.
6. PROVIDE MIN R2.0 UNDER-FLOOR INSULATION
BATTS TO ALL SUSPENDED FLOORS ABOVE
ENCLOSED SUB-FLOORS.

# FLOOD CONSTRUCTION NOTES: (REFER TO FLOOD IMPACT ASSESSMENT, NOVEMBER 2018, PREPARED BY HYDRO SPACIAL PTY LTD). - The 1% AEP flood level is 859.08 m AHD for the upper ground

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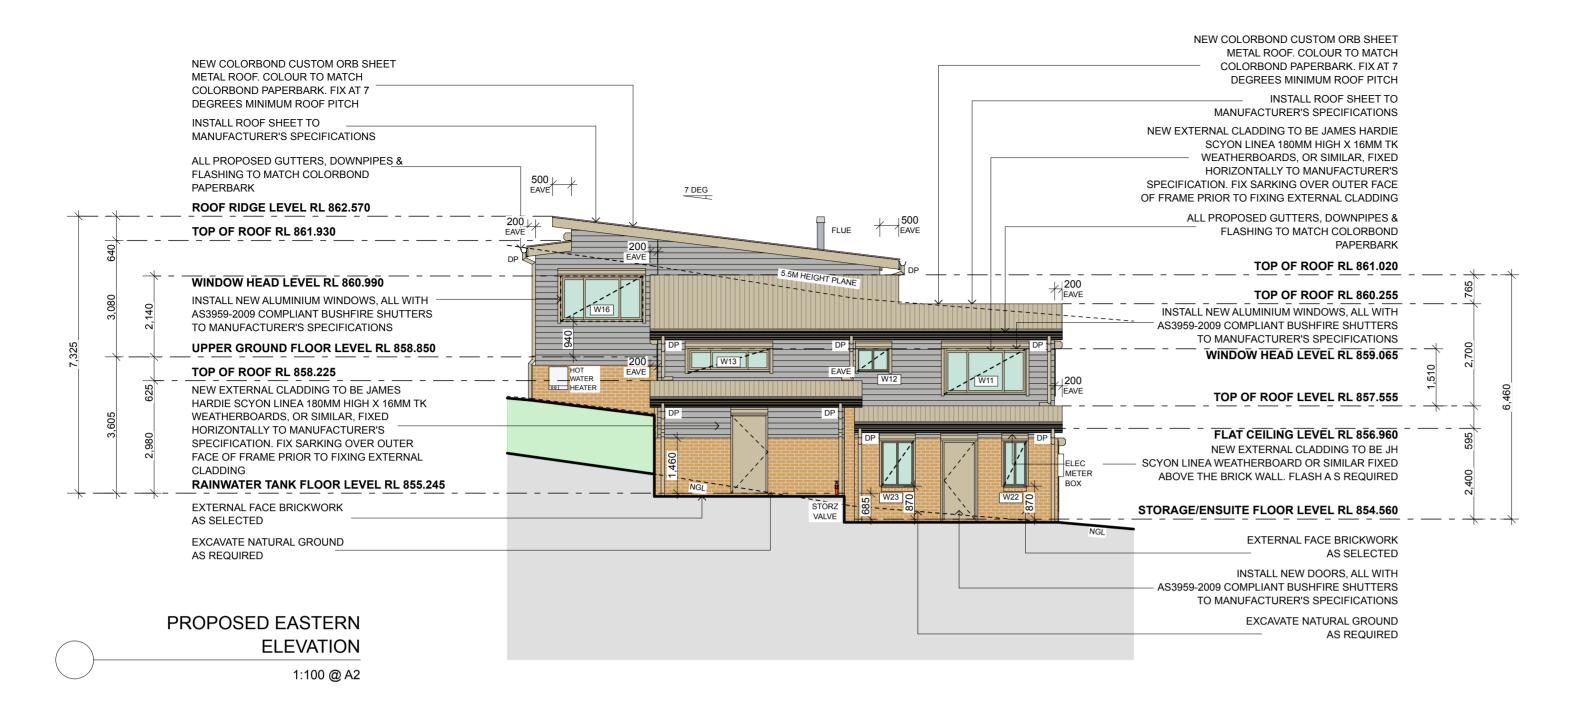
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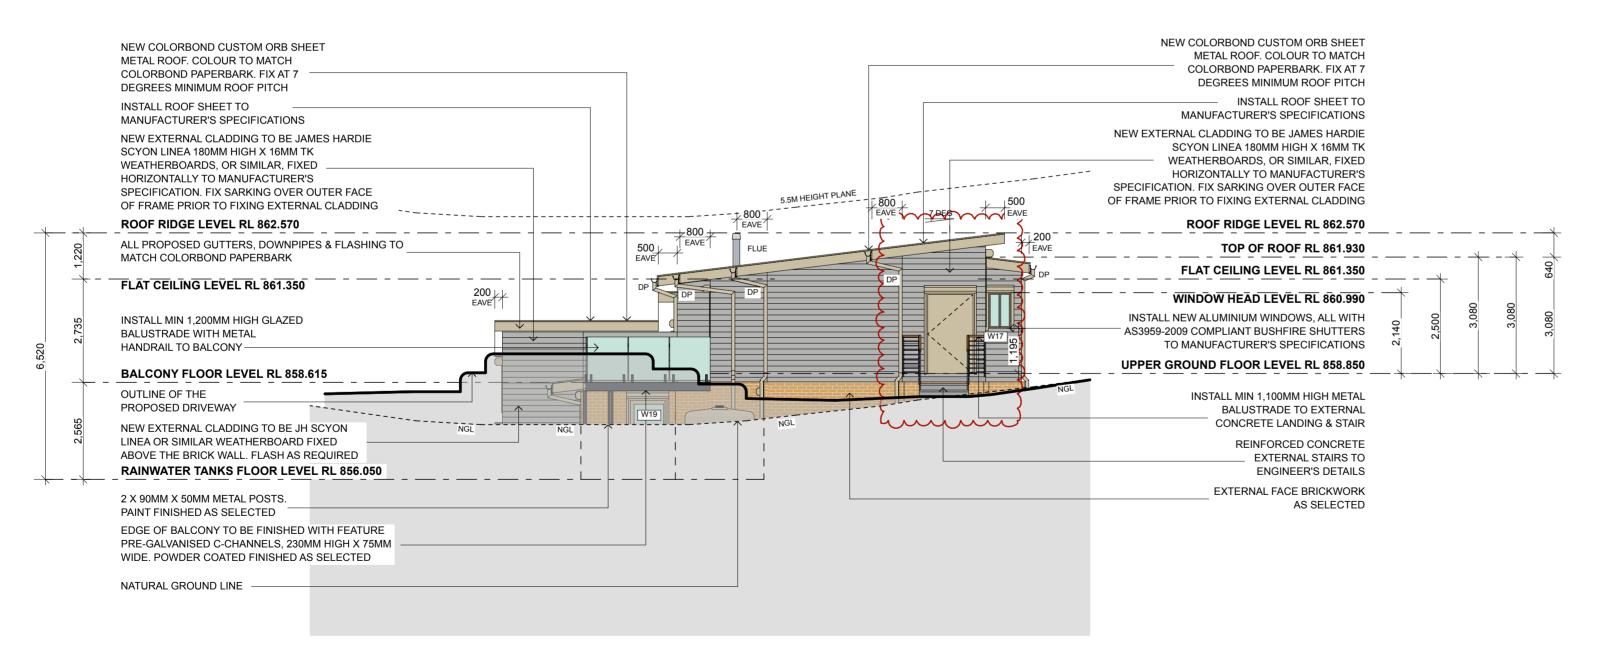
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the flood forces.

AMENDMENTS:			PROJECT:			
В	For Development Approval	21-09-22	PROPOSED RESIDENCE NO 40 WILSON STREET, WENTWORTH FALLS, NSW 2782 (PART LOT 5 IN SEC B DP 3497) For Mr Chang Kyun Son.	9TY LIMIT  3 HOME S  NSW, 2770  Fax: (02) 475	STREET, FAULCONBRIDGE	
			PROPOSED SOUTHERN (REAR) ELEVATION	1:100 @ A2  DATE: 21/09/2022	DRAWN:  JVH/VK  CHECKED:  JVH	DRAWING NO:





## PROPOSED WESTERN ELEVATION

1:100 @ A2

# BAL RATING: FZ-FLAME ZONE

**INSULATION NOTES:** 

1. PROVIDE 75MM FOIL BACKED BLANKET TO UNDERSIDE OF ALL ROOF SHEETS.
2. PROVIDE MIN R3.5 INSULATION BATTS TO FLAT CEILINGS, & MIN R3.5 INSULATION BATTS TO RAKED CEILINGS.
2. PROVIDE MIN R3.5 INSULATION.

3. PROVIDE MIN R2.5 INSULATION
BATTS TO ALL FRAMED EXTERNAL WALLS.
4. PROVIDE MIN R2.5 INSULATION
BATTS TO ALL BRICK VENEER EXTERNAL WALLS.
5. PROVIDE MIN R1.0 INSULATION
TO ALL CAVITY BRICK EXTERNAL WALLS.
6. PROVIDE MIN R2.0 UNDER-FLOOR INSULATION
BATTS TO ALL SUSPENDED FLOORS ABOVE
ENCLOSED SUB-FLOORS.

EXTERIOR COLOURS & FINISHES:

1. PROPOSED ROOF: COLORBOND CUSTOM ORB SHEET METAL ROOF IN COLORBOND PAPERBARK.

2. GUTTERS, DOWNPIPES & FLASHING TO BE COLORBOND PAPERBARK.

3. EXTERNAL WALL CLADDING: JAMES HARDIE SCYON LINEA EXTERNAL WALL CLADDING, FIX VERTICALLY.

4. NEW WINDOW & DOOR FRAMES TO BE POWDER COATED TO MATCH COLORBOND PAPERBARK.

5. BUSHFIRE SHUTTERS TO BE POWDER COATED TO MATCH COLORBOND PAPERBARK.

5. NEW FACE BRICKWORK TO BE AUSTRAL BRICK'S EVERY DAY LIFE RANGE IN COLOUR 'ENGAGE', OR SIMII AP

INTERNAL WALL NOTES:
ALL INTERNAL WALLS TO BE 92MM
METAL STUD WALLS LINED WITH 10MM
GYPROCK PLASTERBOARD SHEETS
DIRECT FIXED TO EITHER SIDE UNLESS

FLOOD CONSTRUCTION NOTES: (REFER TO FLOOD IMPACT ASSESSMENT, NOVEMBER 2018, PREPARED BY HYDRO SPACIAL PTY LTD).

NOTED OTHERWISE

- The 1% AEP flood level is **859.08 m AHD** for the upper ground floor level.

- The required FFL for the upper ground floor level is **859.35 m AHD**.

- There is no flood extent to the ground floor level or the lower

ground floor level, therefore there are no requirements for finished floor levels to the lower levels of the house.

- It is recommended that the building is constructed using flood compatible materials below the level of the 1% AEP plus freeboard and constructed in such a manner that it can withstand the flood forces.

It is recommended that the building is constructed as per BCA/NCC Construction of Buildings in Flood Hazard Areas.

NOTES:

1. ALL CONSTRUCTION DETAILING TO BE TO BAL FZ-FLAME ZONE REQUIREMENTS.
2. ALL NEW WORK TO COMPLY WITH AS 3959 SECTIONS 3 & 9 CONSTRUCTION OF BUILDINGS

IN BUSHFIRE PRONE AREAS.
3. NEW EXTERNAL CLADDING TO BE JAMES HARDIE SCYON LINEA180MM HIGH X 16MM TK WEATHERBOARD WALL CLADDING, FIXED HORIZONTALLY TO MANUFACTURER'S SPECIFICATION, & TO ACHIEVE A MIN FRL 60/60/60 IN ACCORDANCE WITH AS 1530 (UNLESS NOTED OTHERWISE). LINE 2 X 16MM FIRECHEK GYPROCK SHEETS TO THE OUTSIDE OF THE WALL STUD. FIX SARKING OVER OUTER FACE OF SHEETS PRIOR TO FIXING EXTERNAL CLADDING.
4. ALL FLOOR FRAMING BEAMS, ROOF/CEILING BEAMS, CONCRETE SLAB & FOOTINGS TO ENG. DETAILS.
5. ALL FOOTINGS & PIERS TO BE TO ENG. DETAILS.
6. CONFIRM ALL EXCAVATION REQUIREMENTS PRIOR TO CONSTRUCTION.
6. PROVIDE ALL FLASHING AS PER BCA/NCC REQUIREMENTS.

AMENDMENTS:
B For Development Approval 21-09-22

PROJECT:

PROPOSED RESIDENCE
NO 40 WILSON STREET,
WENTWORTH FALLS, NSW 2782
(PART LOT 5 IN SEC B DP 3497)

For
Mr Chang Kyun Son.
DRAWING:

PROPOSED EASTERN &
WESTERN ELEVATIONS

PROPOSED SEWER &
WASTEWATER NOTE:

1. RISING MAIN AND CONNECTION
TO SEWER TO HYDRAULIC
ENGINEER'S DETAIL.

2. CONNECT WASTEWATER TO
SEWER TO HYDRAULIC

ENGINEER'S DETAIL.

BIO-BUILDING DESIGN PTY LIMITED ARCHITECTS

3 HOME STREET, FAULCONBRIDGE NSW, 2776 Tel: (02) 4751 1846 Fax: (02) 4751 7098 Email: biobuild@pnc.com.au Registered Architect: John Van der Have ARB 3690

SCALE: DRAWN: DRAWING NO:


1:100 @ A2

DATE: CHECKED: JVH

21/09/2022 JVH

PROPOSED SEWER & WASTEWATER NOTE: 1. RISING MAIN AND CONNECTION TO SEWER TO HYDRAULIC ENGINEER'S DETAIL. 2. CONNECT WASTEWATER TO SEWER TO HYDRAULIC ENGINEER'S DETAIL.


13

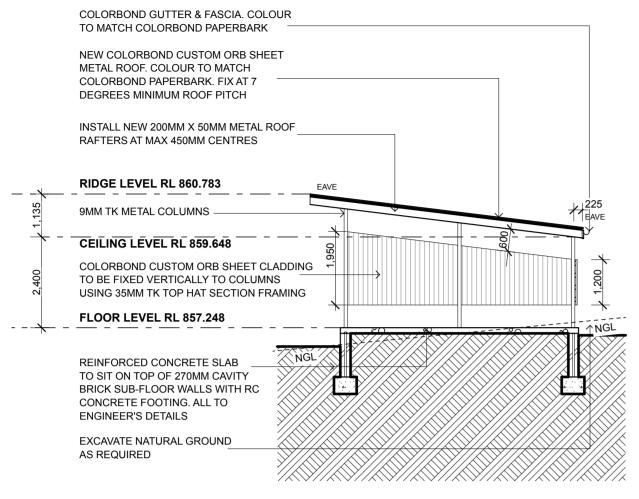

METAL ROOF. COLOUR TO MATCH COLORBOND PAPERBARK. FIX AT 7 DEGREES MINIMUM ROOF PITCH 9MM TK METAL COLUMNS COLORBOND GUTTER & FASCIA. COLOUR TO MATCH COLORBOND PAPERBARK 200 EAVE **RIDGE LEVEL RL 860.783** CEILING LEVEL RL 859.648 COLORBOND CUSTOM ORB SHEET CLADDING TO BE FIXED VERTICALLY TO COLUMNS USING 35MM TK TOP HAT SECTION FRAMING NGL FLOOR LEVEL RL 857.248 REINFORCED CONCRETE SLAB TO ENGINEER'S **DETAILS** 

NEW COLORBOND CUSTOM ORB SHEET METAL ROOF. COLOUR TO MATCH COLORBOND PAPERBARK. FIX AT 7 **DEGREES MINIMUM ROOF PITCH** INSTALL NEW 200MM X 50MM METAL ROOF RAFTERS AT MAX 450MM CENTRES EAVE **RIDGE LEVEL RL 860.783** 9MM TK METAL COLUMNS CEILING LEVEL RL 859.648 COLORBOND CUSTOM ORB SHEET CLADDING TO BE FIXED VERTICALLY TO COLUMNS USING 35MM TK TOP HAT SECTION FRAMING 4,500L RWT FLOOR LEVEL RL 857.248 REINFORCED CONCRETE SLAB TO ENGINEER'S **DETAILS** CONSTRUCT REINFORCED CONCRETE SLAB ON SUB-FLOOR WALLS FOR RAINWATER TANK. ALL TO ENGINEER'S DETAILS

## PROPOSED CARPORT SECTION JJ 1:100 @ A2

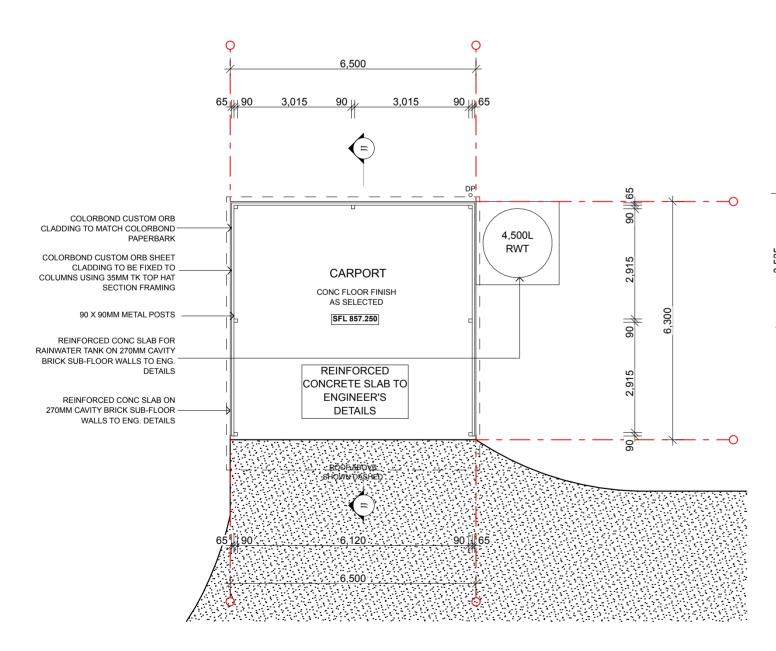

## PROPOSED CARPORT NORTHERN ELEVATION

NEW COLORBOND CUSTOM ORB SHEET

1:100 @ A2

COLORBOND GUTTER & FASCIA. COLOUR TO MATCH COLORBOND PAPERBARK NEW COLORBOND CUSTOM ORB SHEET METAL ROOF. COLOUR TO MATCH COLORBOND PAPERBARK. FIX AT 7 DEGREES MINIMUM ROOF PITCH INSTALL NEW 200MM X 50MM METAL ROOF RAFTERS AT MAX 450MM CENTRES **RIDGE LEVEL RL 860.783** EAVE 9MM TK METAL COLUMNS -CEILING LEVEL RL 859.648 COLORBOND CUSTOM ORB SHEET CLADDING TO BE FIXED VERTICALLY TO COLUMNS USING 35MM TK TOP HAT SECTION FRAMING 4,500L RWT FLOOR LEVEL RL 857.248 REINFORCED CONCRETE SLAB TO ENGINEER'S **DETAILS** REINFORCED CONCRETE SLAB TO SIT ON TOP OF 270MM CAVITY -BRICK SUB-FLOOR WALLS WITH RC CONCRETE FOOTINGS

## PROPOSED CARPORT SOUTHERN ELEVATION

1:100 @ A2

NEW COLORBOND CUSTOM ORB SHEET METAL ROOF. COLOUR TO MATCH COLORBOND PAPERBARK. FIX AT 7 DEGREES MINIMUM ROOF PITCH INSTALL NEW 200MM X 50MM METAL ROOF RAFTERS AT MAX 450MM CENTRES COLORBOND GUTTER & FASCIA. COLOUR TO MATCH COLORBOND PAPERBARK 7 DEG RIDGE LEVEL RL 860.783 9MM TK METAL COLUMNS CEILING LEVEL RL 859.648 COLORBOND CUSTOM ORB SHEET CLADDING TO BE FIXED VERTICALLY TO COLUMNS USING 35MM TK TOP HAT SECTION FRAMING FLOOR LEVEL RL 857.248 REINFORCED CONCRETE SLAB TO ENGINEER'S **DETAILS** 

## PROPOSED CARPORT **EASTERN ELEVATION**

1:100 @ A2

PROPOSED CARPORT WESTERN ELEVATION

1:100 @ A2

EXTERIOR COLOURS & FINISHES: 1. PROPOSED ROOF: COLORBOND CUSTOM ORB SHEET METAL ROOF IN COLORBOND PAPERBARK. 2. GUTTERS, DOWNPIPES & FLASHING TO BE COLORBOND PAPERBARK 3. EXTERNAL WALL CLADDING: CEMINTEL BARESTONE EXTERNAL WALL CLADDING, FIX VERTICALLY. 4. NEW WINDOW & DOOR FRAMES TO BE POWDER COATED TO MATCH COLORBOND PAPERBARK. 5 BUSHFIRE SHUTTERS TO BE POWDER COATED TO MATCH COLORBOND PAPERBARK. 5. NEW FACE BRICKWORK TO BE AUSTRAL BRICK'S EVERY DAY LIFE RANGE IN COLOUR 'ENGAGE', OR SIMILAR.


AMENDMENTS:

**BIO-BUILDING DESIGN** For Development Approval 01-11-21 PTY LIMITED ARCHITECTS PROPOSED RESIDENCE NO 40 WILSON STREET, WENTWORTH FALLS, NSW 2782 3 HOME STREET, FAULCONBRIDGE (PART LOT 5 IN SEC B DP 3497) NSW, 2776 Tel: (02) 4751 1846 Fax: (02) 4751 7098 Email: biobuild@pnc.com.au Registered Architect: John Van der Have ARB 3690 Mr Chang Kyun Son. DRAWING: JVH/VK PROPOSED CARPORT CHECKED: 01/11/2021 JVH PLAN, SECTION & ELEVATIONS

PROJECT

## PROPOSED CAR-PORT PLAN 1:100 @ A2

**DRAWING SCALE - 1:100** 0m 1m 2m 3m

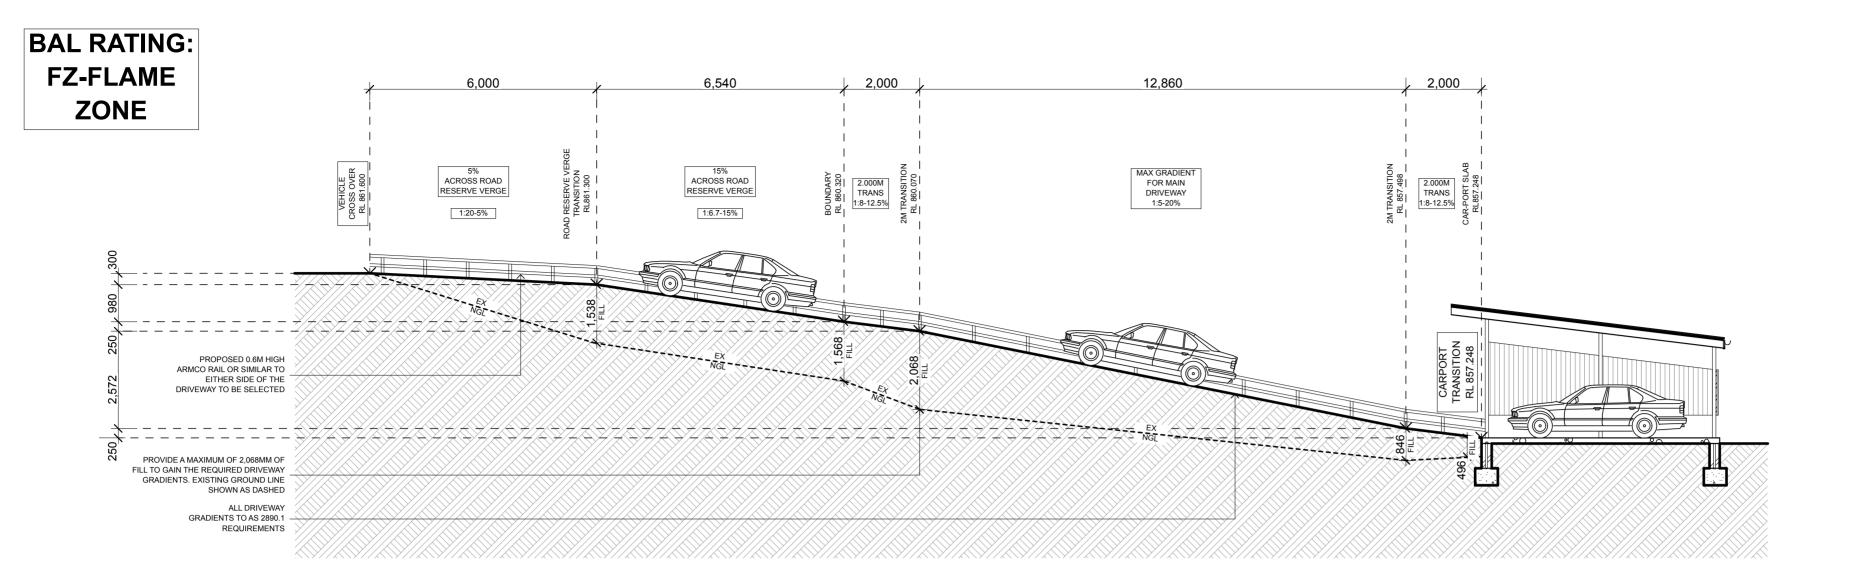


PROPOSED SEWER & WASTEWATER NOTE:

1. RISING MAIN AND CONNECTION TO SEWER TO HYDRAULIC ENGINEER'S DETAIL.

2. CONNECT WASTEWATER TO SEWER TO HYDRAULIC ENGINEER'S DETAIL.

PROPOSED DRIVEWAY GRADIENT LONG SECTION
1:100 @ A2

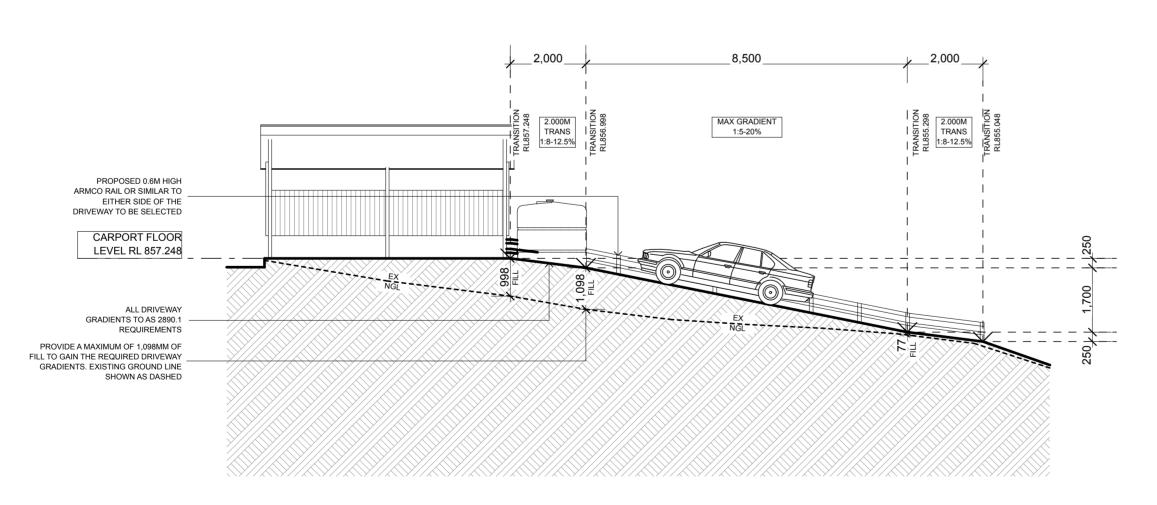

PROPOSED DRIVEWAY GRADIENT SHORT SECTION
1:100 @ A2

EXTERIOR COLOURS & FINISHES:

1. PROPOSED ROOF: COLORBOND CUSTOM ORB SHEET METAL ROOF IN COLORBOND PAPERBARK.

2. GUTTERS, DOWNPIPES & FLASHING TO BE COLORBOND PAPERBARK.


3. EXTERNAL WALL CLADDING: CEMINTEL BARESTONE EXTERNAL WALL CLADDING, FIX VERTICALLY.

4. NEW WINDOW & DOOR FRAMES TO BE POWDER COATED TO MATCH COLORBOND PAPERBARK.

5. BUSHFIRE SHUTTERS TO BE POWDER COATED TO MATCH COLORBOND PAPERBARK.


5. NEW FACE BRICKWORK TO BE AUSTRAL BRICK'S EVERY DAY LIFE RANGE IN COLOUR 'ENGAGE', OR SIMILAR.

AMENDMENTS: A	For Development Approval	01-11-21	PROJECT:  PROPOSED RESIDENCE  NO 40 WILSON STREET, WENTWORTH FALLS, NSW 2782 (PART LOT 5 IN SEC B DP 3497) For Mr Chang Kyun Son.	3 HOME S NSW, 2776 Fax: (02) 4751	TREET, FAULCONB	RIDGE 1 1846 c.com.au
			DRAWING:	SCALE:	DRAWN:	DRAWING NO:
				1:100 @ A2	JVH/VK	44
			PROPOSED DRIVEWAY	DATE:	CHECKED:	14
			SECTIONS	01/11/2021	JVH	

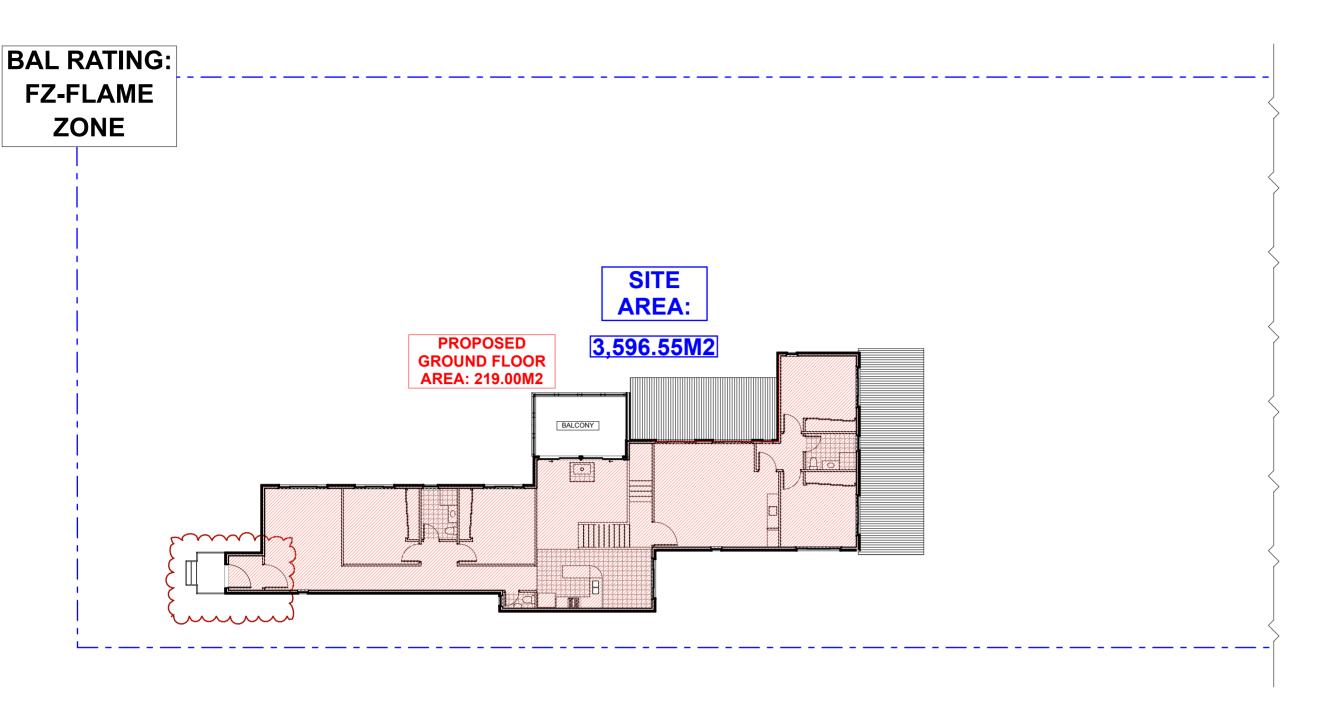

## FSR CALCULATIONS - GROUND FLOOR PLAN

1:200 @ A2

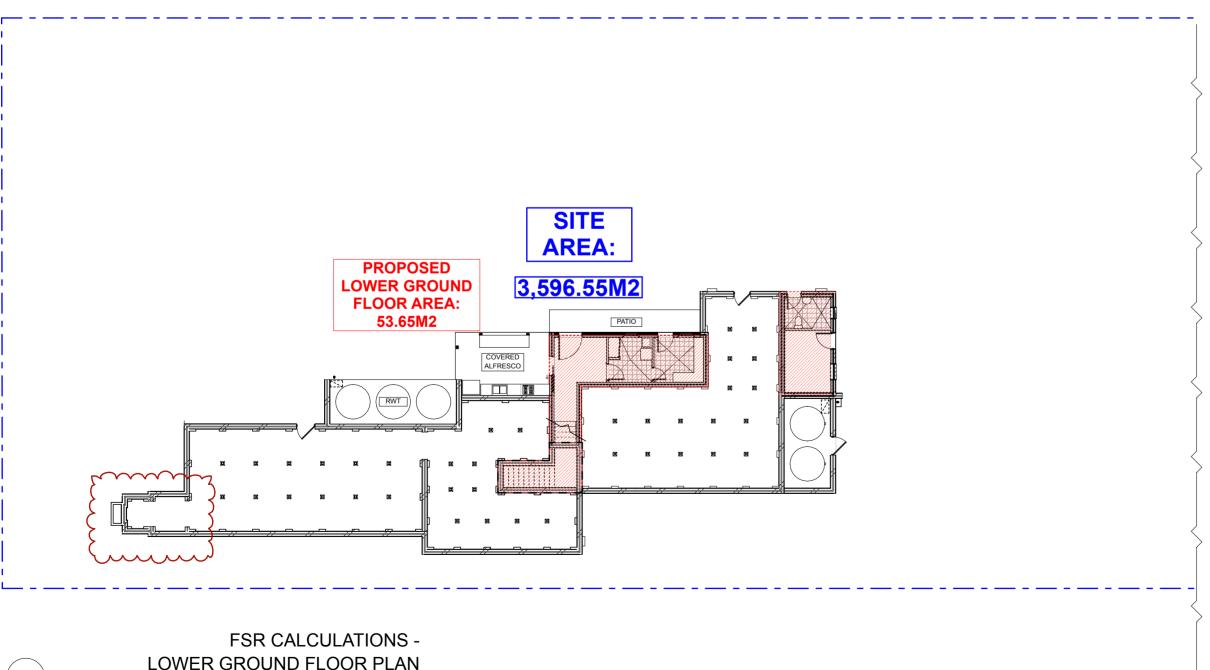

LOWER GROUND FLOOR PLAN

1:200 @ A2

DRAWING SCALE - 1:200 0m | 2m | 4m | 6m

FLOOR SPACE RATIO CALCULATIONS:

LOWER GROUND FLOOR: 53.65 M2

GROUND FLOOR: 219.00 M2

272.65 M2 TOTAL FLOOR AREA: SITE AREA: 3,596.55 M2 FSR: 0.08:1

NOTES: Floor Space Ratio Calculation does not include the alfresco, balcony or private open space areas.

Floor area is measured from the external face of the external walls, and from the internal face of walls separating the building from any other building (measured at a height of

- 1.4 metres above the floor), and excludes:
- any area for common vertical circulation,

such as lifts and stairs,

- storage,

- terraces and balconies with outer walls

less than 1.4 metres high,

- voids above a floor at the level of a


storey or storey above.

Floor area for calculation is measured from the external face of the external walls.

For Development Approval 21-09-22 PROJECT: PROPOSED RESIDENCE NO 40 WILSON STREET, WENTWORTH FALLS, NSW 2782 For Mr Chang Kyun Son. PROPOSED FSR CALCULATIONS **BIO-BUILDING DESIGN** PTY LIMITED ARCHITECTS

> 3 HOME STREET, FAULCONBRIDGE NSW, 2776 Tel: (02) **4751 1846** Fax: (02) 4751 7098 Email: biobuild@pnc.com.au Registered Architect: John Van der Have ARB 3690

JVH/VK 1:200 @ A2 15 21/09/2022 JVH

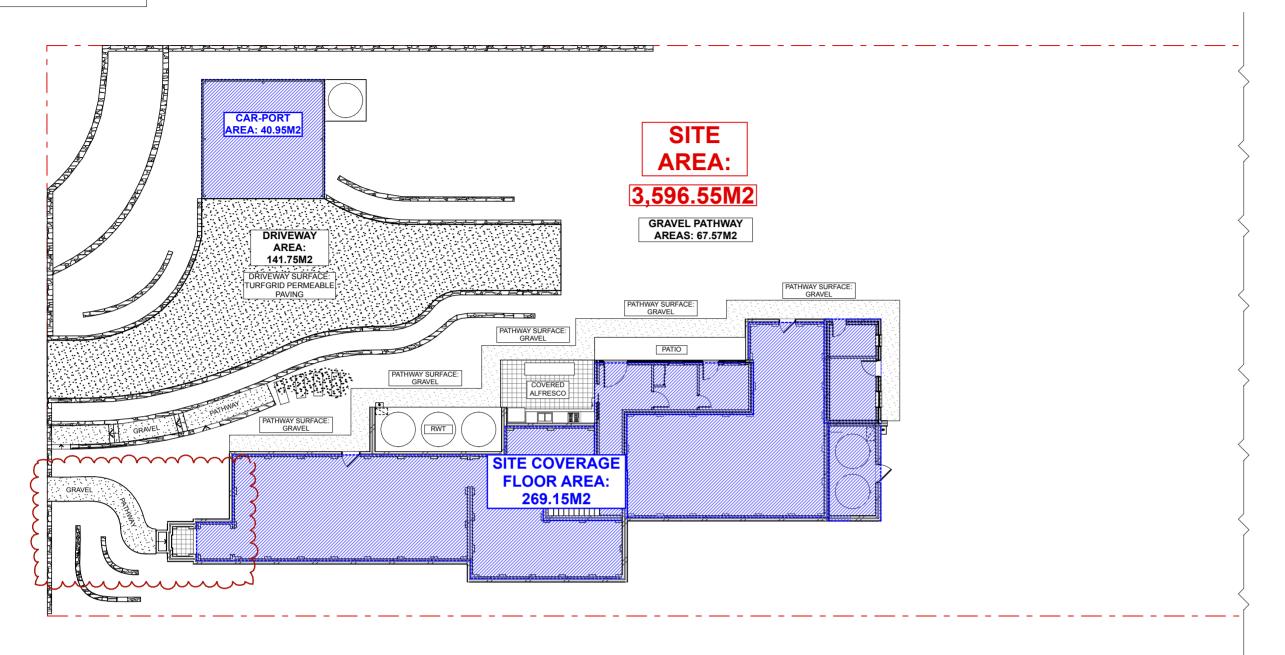

SITE COVERAGE CALCULATIONS

1:200 @ A2

 DRAWING SCALE - 1:200

 0m
 2m
 4m
 6m
 8m
 10m
 12m
 14m
 16m
 18m
 20m

 A2 PAPER SCALE
 0mm
 10mm
 20mm
 30mm
 40mm
 50mm
 60mm
 70mm
 80mm
 90mm
 100mm

## SITE COVERAGE CALCULATIONS: **BUILDING COVERAGE AREA (NOT INCL DRIVEWAY** OR PATHWAYS): PROPOSED RESIDENCE: 269.15 M2 CAR-PORT: 40.95 M2 TOTAL BUILDING AREA: 310.10 M2 SITE AREA IN THE E4 ZONE: 1,840.00 M2 BUILDING AREA AS A PERCENTAGE OF SITE COVERAGE: 16.8% AREA OF E4 PART IS: 30.175M X 61.0M: 1,840M2 16.8% SITE COVERAGE IS 310.10M2/1,840M2: **ALLOWABLE SITE COVERAGE IS:** 384M2 300M2 + (10% OF 840M2: 84M2): THE PROPOSED HARD SURFACES ARE WELL WITHIN THIS ALLOWANCE. 1,840M2 - 310M2: 1,530M2, OR 83% OF THE E4 LAND, **WILL REMAIN PERVIOUS.** WE THEREFORE COMPLY WITH LEP 2015, CLAUSE 4.4A(7)(b). BUILDING COVERAGE AREA (INCLUDING DRIVEWAY & PATHWAYS): PROPOSED RESIDENCE: 269.15 M2 CAR-PORT: 40.95 M2

GRAVEL PATHWAYS: 67.57M2

TURFGRID DRIVEWAY: 141.75 M2

**NOTES:** BMCC'S LEP defines site coverage as the portion of a site's area which is covered by buildings. However, the following are not included for the purpose of calculating site coverage:
- any basement,

- any part of an awning that is outside the outer walls of a building and that adjoins the street frontage or other site boundary, any eaves,
- unenclosed balconies, decks, pergolas and the like.

Floor area for calculation is measured from the external face of the external walls.

AMENDMENTS: B	For Development Approval	21-09-22	PROJECT:		ILDING DE	
			PROPOSED RESIDENCE NO 40 WILSON STREET, WENTWORTH FALLS, NSW 2782 (PART LOT 5 IN SEC B DP 3497) For Mr Chang Kyun Son.	NSW, 2776 Fax: (02) 475	TREET, FAULCONB	51 1846 c.com.au
		DRAWING:	SCALE:	DRAWN:	DRAWING NO	
				1:200 @ A2	JVH/VK	
			PROPOSED SITE COVERAGE CALCULATIONS	DATE: 21/09/2022	CHECKED: JVH	16

#### PROPOSED PRIMARY RESIDENCE BASIX COMMITMENTS: WATER COMMITMENTS: Certificate No 1218331S\_03 www. **FIXTURES**

- SHOWER HEAD TO BE MINIMUM 3 STAR RATED (> 7.5 but <= 9 L/min)
- TOILET SYSTEM TO BE MINIMUM 3 STAR RATED - KITCHEN TAPS TO BE MINIMUM 3 STAR RATED
- BATHROOM TAPS TO BE MINIMUM 3 STAR RATED

#### **ALTERNATIVE WATER**

- INSTALL RAINWATER TANKS WITH A 27,000 LT RAINWATER CAPACITY WHERE INDICATED TO AUTHORITY REQUIREMENTS
- RUN-OFF FROM A MINIMUM OF 349 SQM OF ROOF AREA IS
- TO BE COLLECTED IN THE TANK.
- THE TANK IS TO BE CONNECTED TO ALL TOILETS IN THE DEVELOPMENT & AN EXTERNAL TAP.

### THERMAL COMFORT COMMITMENTS:

#### FLOORS, WALLS, CEILINGS & ROOF

FLOOR, WALLS, CEILING & ROOF MUST BE CONSTRUCTED IN ACCORDANCE WITH THE FOLLOWING R-VALUES:

- 1. FLOOR: CONCRETE SLAB ON GROUND: NIL.
- 2. SUSPENDED FLOOR ABOVE ENCLOSED SUB-FLOOR: ADD R1.8 INSULATION.
- 3. EXTERNAL WALL: CAVITY BRICK: ADD R1.0 INSULATION.
- 4. EXTERNAL WALL: BRICK VENEER: ADD R2.26 INSULATION.
- 5. EXTERNAL WALLS: FRAMED (WEATHERBOARD, FIBRE CEMENT,

METAL CLAD) ADD R2.4 INSULATION.

6. CEILING & ROOF: FLAT CEILING/PITCHED ROOF.

CEILING: ADD MIN R3.2 INSULATION TO FRAME. ROOF: ADD FOIL BACKED BLANKET (75MM).

Framed; Light (solar absorptance < 0.475)

7. CEILING & ROOF: RAKED CEILING/PITCHED OR SKILLION ROOF. CEILING: ADD MIN R3.5 INSULATION TO FRAME. ROOF: ADD FOIL

BACKED BLANKET (75MM).

Framed; Light (solar absorptance < 0.475)

#### **ENERGY COMMITMENTS:**

- HOTWATER SYSTEM: GAS INSTANTANEOUS,

6 STAR PERFORMANCE RATED. - COOLING SYSTEM: LIVING AREA: PHASE 3 AIR COND.

4 STAR RATED.

BEDROOM: PHASE 3 AIR COND.

4 STAR RATED.

- HEATING SYSTEM: LIVING AREA: PHASE 3 AIR COND.

4 STAR RATED.

BEDROOM: PHASE 3 AIR COND.

4 STAR RATED.

AIR CON TO BE DAY/NIGHT ZONED BETWEEN

LIVING AREAS & BEDROOMS AREAS.

- VENTILATION:

**EXHAUST SYSTEM:** 

BATHROOM: INDIVIDUAL FAN,

NOT DUCTED, MANUAL ON/OFF SWITCH.

KITCHEN: INDIVIDUAL FAN, NOT DUCTED, MANUAL

ON/OFF SWITCH.

LAUNDRY: NATURAL VENTILATION. - ARTIFICIAL LIGHTING: DEDICATED FLUORESCENT OR LED TO ALL ROOMS.

#### OTHER:

- INSTALL A GAS COOKTOP & ELECTRIC OVEN.
- THE REFRIGERATOR SPACE IS TO BE OPEN & WELL VENTILATED.
- INSTALL A FIXED OUTDOOR CLOTHES DRYING LINE.

PROPOSED BASIX COMITTMENTS

- @ A2

0mm | 10mm | 20mm | 30mm | 40mm | 50mm | 60mm | 70mm | 80mm | 90mm | 100mm


W1	N	1200MM X 2600MM	ALUMINIUM, SINGLE, CLEAR	EAVE 900MM, 400MM ABOVE WINDOW/DOOR HEAD	NOT OVERSHADOW
W2	N	1200MM X 2100MM	ALUMINIUM, SINGLE, CLEAR	EAVE 900MM, 400MM ABOVE WINDOW/DOOR HEAD	NOT OVERSHADOW
W3	N	1200MM X 800MM	U-VALUE: 6.6, SHGC: 0.441-0.539 (ALUMINIUM: SINGLE, TINT)	EAVE 900MM, 400MM ABOVE WINDOW/DOOR HEAD	NOT OVERSHADOW
W4	N	1200MM X 2100MM	ALUMINIUM, SINGLE, CLEAR	EAVE 900MM, 400MM ABOVE WINDOW/DOOR HEAD	NOT OVERSHADOW
W5	N	2100MM X 2100MM	ALUMINIUM, SINGLE, CLEAR	EAVE 900MM, 200MM ABOVE WINDOW/DOOR HEAD	NOT OVERSHADOW
W6	N	2100MM X 2100MM	ALUMINIUM, SINGLE, CLEAR	EAVE 900MM, 200MM ABOVE WINDOW/DOOR HEAD	NOT OVERSHADOW
W7	N	900MM X 2100MM	ALUMINIUM, SINGLE, CLEAR	EAVE 200MM, 500MM ABOVE WINDOW/DOOR HEAD	NOT OVERSHADOW
W8	N	900MM X 2100MM	ALUMINIUM, SINGLE, CLEAR	EAVE 200MM, 450MM ABOVE WINDOW/DOOR HEAD	NOT OVERSHADOW
W9	N	600MM X 600MM	ALUMINIUM, SINGLE, CLEAR	EAVE 200MM, 240MM ABOVE WINDOW/DOOR HEAD	NOT OVERSHADOW
W10	N	1200MM X 600MM	ALUMINIUM, SINGLE, CLEAR	EAVE 200MM, 790MM ABOVE WINDOW/DOOR HEAD	NOT OVERSHADOW
W20	N	1200MM X 800MM	ALUMINIUM, SINGLE, CLEAR	EAVE 900MM, 150MM ABOVE WINDOW/DOOR HEAD	NOT OVERSHADOW
W21	N	1200MM X 800MM	U-VALUE: 6.6, SHGC: 0.441-0.539 (ALUMINIUM: SINGLE, TINT)	EAVE 900MM, 150MM ABOVE WINDOW/DOOR HEAD	NOT OVERSHADOW
W11	Е	1200MM X 2100MM	ALUMINIUM, SINGLE, CLEAR	EAVE 900MM, 200MM ABOVE WINDOW/DOOR HEAD	NOT OVERSHADOW
W12	Е	600MM X 800MM	ALUMINIUM, SINGLE, CLEAR	EAVE 900MM, 200MM ABOVE WINDOW/DOOR HEAD	NOT OVERSHADOW
W13	Е	600MM X 2100MM	ALUMINIUM, SINGLE, CLEAR	EAVE 900MM, 200MM ABOVE WINDOW/DOOR HEAD	NOT OVERSHADOW
W16	Е	900MM X 700MM	ALUMINIUM, SINGLE, CLEAR	EAVE 200MM, 1090MM ABOVE WINDOW/DOOR HEAD	NOT OVERSHADOW
W22	Е	1200MM X 600MM	U-VALUE: 6.6, SHGC: 0.441-0.539 (ALUMINIUM: SINGLE, TINT)	EAVE 740MM, 220MM ABOVE WINDOW/DOOR HEAD	NOT OVERSHADOW
W23	Е	1200MM X 800MM	ALUMINIUM, SINGLE, CLEAR	EAVE 740MM, 220MM ABOVE WINDOW/DOOR HEAD	NOT OVERSHADOW
W14	S	2400MM X 600MM	ALUMINIUM, SINGLE, CLEAR	EAVE 200MM, 500MM ABOVE WINDOW/DOOR HEAD	NOT OVERSHADOW
W15	S	1800MM X 600MM	ALUMINIUM, SINGLE, CLEAR	EAVE 200MM, 500MM ABOVE WINDOW/DOOR HEAD	NOT OVERSHADOW
W18	S	1800MM X 600MM	ALUMINIUM, SINGLE, CLEAR	EAVE 200MM, 300MM ABOVE WINDOW/DOOR HEAD	NOT OVERSHADOW
W17	W	900MM X 700MM	U-VALUE: 6.6, SHGC: 0.441-0.539 (ALUMINIUM: SINGLE, TINT)	EAVE 200MM, 600MM ABOVE WINDOW/DOOR HEAD	NOT OVERSHADOW
W19	W	2090MM X 900MM	ALUMINIUM, SINGLE, CLEAR	SOLID OVERHANG 3300MM, 200MM ABOVE WINDOW/ DOOR HEAD	NOT OVERSHADOW

### **BIO-BUILDING DESIGN** PTY LIMITED ARCHITECTS PROPOSED RESIDENCE

NO 40 WILSON STREET, WENTWORTH FALLS NSW 2782 (PART LOT 5 IN SEC B DP 3497) For Mr Chang Kyun Son.

21/09/2022

PROPOSED BASIX COMMITMENTS 17 JVH/VK

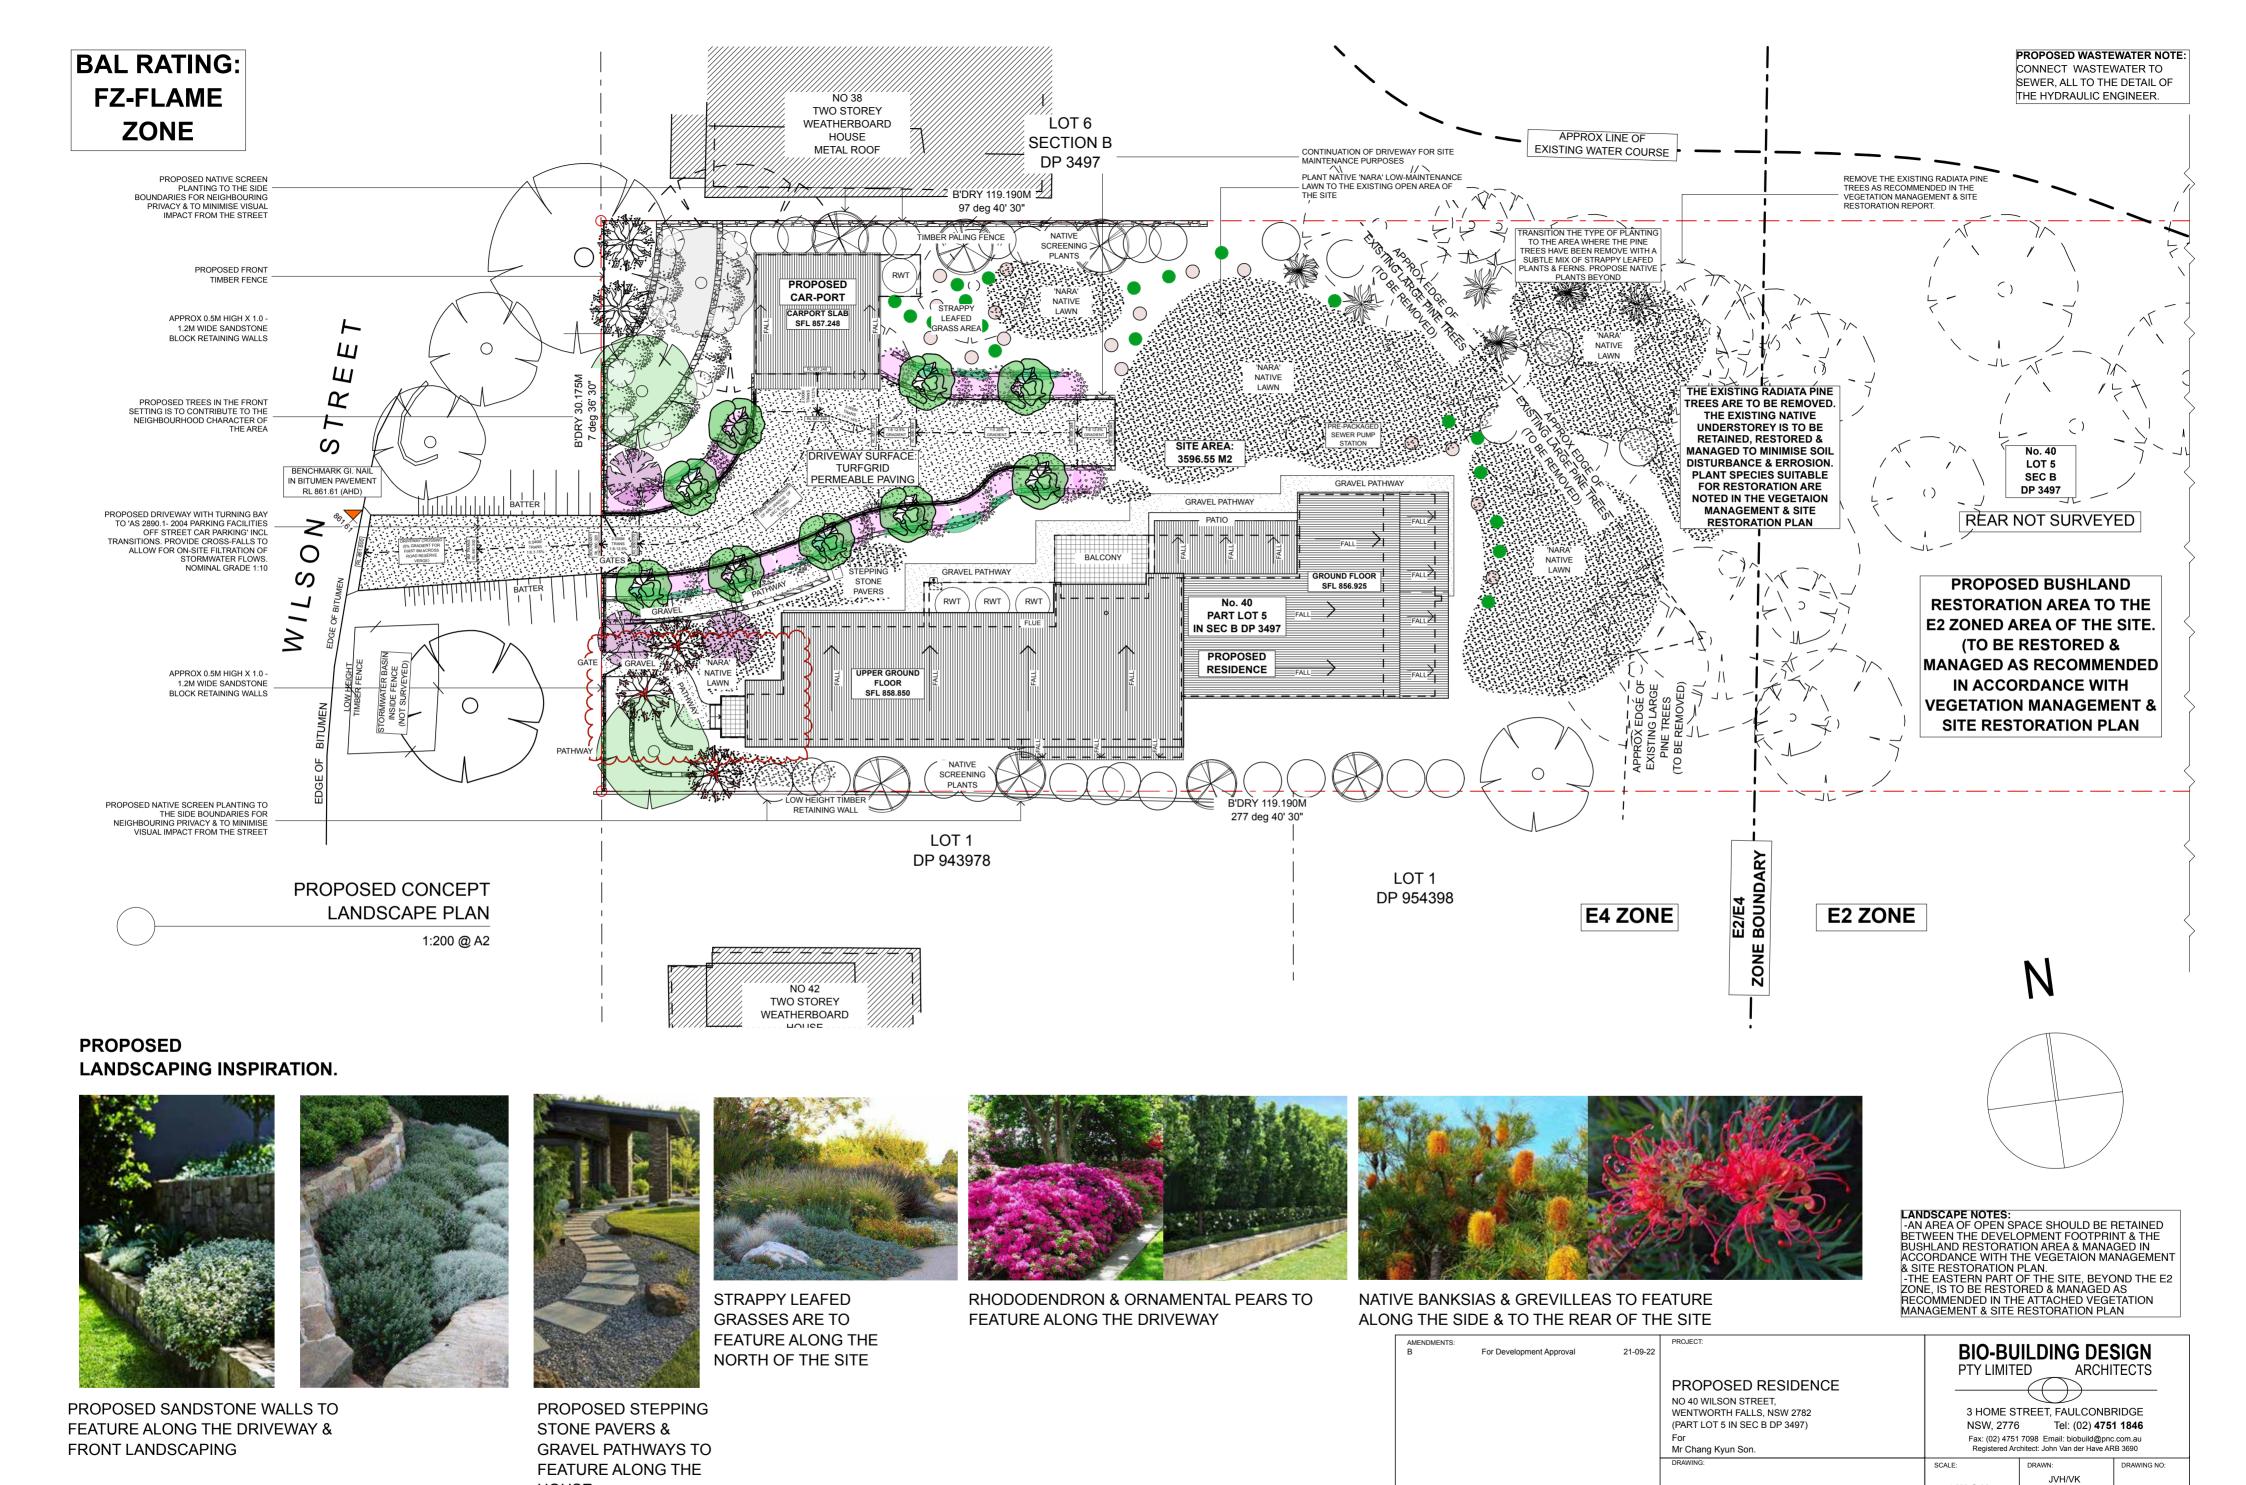

1:200 @ A2

21/09/2022

JVH

18

PROPOSED CONCEPT

LANDSCAPE PLAN

 DRAWING SCALE - 1:200

 0m
 2m
 4m
 6m
 8m
 10m
 12m
 14m
 16m
 18m
 20m

 A2 PAPER SCALE
 0mm
 10mm
 20mm
 30mm
 40mm
 50mm
 60mm
 70mm
 80mm
 90mm
 100mm

HOUSE

	SYMBOL	BOTANICAL NAME	COMMON NAME	MATURE HEIGHT & WIDTH	NUMBER OF PLANTS REQUIRED	PLANT IMAGE
	2 2 2 2 2 2 2 2 2 2 2 2 2 2 2 2 2 2 2	Abelia x grandiflora 'Nana'	Dwarf Abelia	Ht: 1.20m W: 1.20m	12	
		Acer palmatum 'Atropurpureum'	Purple Japanese Maple	Ht: 4.00m W: 3.00m	3	
		Azalea purpurea 'Shiraz'	Azalea 'Shiraz'	Ht: 1.00m W: 1.00m	8	
		Blechnum cartiligeneum	Soft Water Fern	Ht: 1.50m W: 1.50m	3	
		Blechnum nudum	Fishbone Water Fern	Ht: 1.00m W: 1.00m	3	
		Banksia marginata	Silver Banksia	Ht: 4.00m W: 4.00m	7	
		Grevillea 'Robyn Gordon'	Grevillea	Ht: 1.50m W: 1.50m	28	
	E STANDARD CONTRACTOR OF THE STANDARD CONTRACTOR	Largerstroemia indica 'Nachez'	White Flowering Crepe Myrtle	Ht: 8.00m W: 6.00m	1	
		Liquidambar styraciflua 'Jennifer Carrol'	Liquid Amber	Ht: 8.00m W: 4.00m	2	
		Magnolia x 'Heaven Scent'	Magnolia Heaven Scent	Ht: 2.00m W: 2.00m	3	
		Prunus yedoensis x subhirtella 'Snofozam'	Snow Mountains Weeping Cherry	Ht: 2.00m W: 2.00m	2	
		Pyrus calleryana 'Capital'	Ornamenal Pear	Ht: 8.00m W: 3.00m	7	
		Phormium tenax 'Sweet Mist'	New Zealand Flax	Ht: 0.40m W: 0.40m	17	
		Lomandra longifolia 'Tanika'	Tanika Lomandra	Ht: 0.60m W: 0.60m	19	
		Viola hederacea	Native Violet	Ht: 0.60m W: 0.60m	50	
		Rhododendron cvs	Rhododendron 'Midnight' (Purple/pink flowering)	Ht: 1.5m W: 1.5m	22	
		Nara zoysia	Nara Native Turf	-	-	
		Existing trees to be retained				
A2 PAPER SCALE	40mm \$50mm \$60mm \$700	Existing trees to be removed				



0.5m high X 1.0 - 1.2M wide sandstone block retaining walls



Gravel pathway

# PROPOSED CONCEPT LANDSCAPE PLANT LIST

- @ A2

AMENDMENTS: A	For Development Approval	01-11-21	PROPOSED RESIDENCE NO 40 WILSON STREET, WENTWORTH FALLS, NSW 2782 (PART LOT 5 IN SEC B DP 3497) For Mr Chang Kyun Son.	9TY LIMITI  3 HOME S' NSW, 2776 Fax: (02) 4751	BIO-BUILDING DESIGN PTY LIMITED ARCHITECTS  3 HOME STREET, FAULCONBRIDGE NSW, 2776 Tel: (02) 4751 1846 Fax: (02) 4751 7098 Email: biobuild@pnc.com.au Registered Architect: John Van der Have ARB 3690	
			DRAWING:	SCALE:	DRAWN: JVH/VK	DRAWING NO:
			PROPOSED CONCEPT LANDSCAPE PLANT LIST	1:100 @ A2 DATE: 01/11/2021	CHECKED:	19

